| FIRE / SMOKE BARRIER DESIGNATIONS   |  |  |  |  |  |  |
|---|--|--|--|--|--|--|
| THE SYMBOLS SHOWN ARE FOR THE CONVENIENCE OF THE CONTRACTOR. THE CONTRACTOR SHALL VERIFY RATINGS WITH THE LATEST SET OF ARCHITECTURAL PLANS AND FURNISH ALL MATERIALS REQUIRED TO COMPLY WITH THOSE RATINGS WHETHER SHOWN OR NOT. |  |  |  |  |  |  |
| ALL FLOOR ASSEMBLIES SHALL BE DESIGNATED AS 2 HOUR FIRE, BARRIER(S), UNLESS NOTED OTHERWISE ON THE PLANS. RATINGS WERE ACQUIRED FROM THE ARCHITECTURAL PLANS.   |  |  |  |  |  |  |
| 1 HOUR FIRE BARRIER   |  |  |  |  |  |  |
| 2 HOUR FIRE BARRIER   |  |  |  |  |  |  |
| SMOKE BARRIER   |  |  |  |  |  |  |

| FIRE SPRINKLER USAGE SCHEDULE                 |           |                      |                         |          |                  |                |  |                  |
|---|-----------|----------------------|-------------------------|----------|------------------|----------------|--|------------------|
|   | AREA      | SPRINKLER            |                         |          |                  |                |  |                  |
| AREA TYPE (NOTE 1 & 6)                        | HAZARD    | SYMBOL (NOTES 4 & 5) | TYPE                    | RESPONSE | FINISH           | TEMPERATURE °F | MANUFACTURER & MODEL   | REMARKS          |
| AREA OF EXPOSED<br>CONSTRUCTION               | SEE PLANS | SPR-1                | UPRIGHT                 | QUICK    | ROUGH BRASS      | 155            | VIKING VK, RELIABLE F1FR,<br>TYCO TY-FRB, VICTAULIC V2704                  | NOTES 2, 3, 7, 8 |
| AREAS WITH FINISHED<br>CEILINGS (ACT/DRYWALL) | SEE PLANS | SPR-2                | RECESSED PENDENT        | QUICK    | WHITE            |                | VIKING VK, RELIABLE F1FR,<br>HIGH PRESSURE TYCO TY-FRB,<br>VICTAULIC V2708 | NOTES 2, 3, 7, 8 |
| SKYLIGHTS                                     | SEE PLANS | SPR-3                | RECESSED SIDEWALL       | QUICK    | WHITE            | 155            | VIKING VK, RELIABLE F1FR,<br>TYCO TY-FRB, VICTAULIC V2710                  | NOTES 2, 3, 7, 8 |
| VESTIBULES                                    | SEE PLANS | SPR-4                | DRY RECESSED<br>PENDENT | QUICK    | WHITE            | 155            | VIKING VK, RELIABLE F3QR,<br>TYCO DS, VICTAULIC V3606                      | NOTES 2, 3, 7, 8 |
| HOLDING                                       | SEE PLANS | SPR-5                | INSTITUTIONAL PENDANT   | QUICK    | CHROME<br>PLATED | 155            | VIKING VK410, RELIABLE, TYCO, VICTAULIC                                    | NOTES 2, 3, 7, 8 |

## NOTES:

- SEE FLOOR PLANS FOR ZONING REQUIREMENTS.
   SPRINKLER SHALL HAVE COLOR CODED BULB THERMAL ELEMENT.
   ALL SPRINKLERS SHALL BE UL/FM LISTED.
   CONTRACTOR TO VERIFY SPRINKLER REQUIREMENTS BASED ON ACTUAL INSTALLATION, USAGE, ARCHITECTURAL CLING PLANS AND NFPA 13 REQUIREMENTS.
- SYMBOL IS PRIMARILY FOR IDENTIFYING SPRINKLERS IN SUBMITTALS. IT MAY OR MAY NOT BE FOUND ELSEWHERE ON THE DRAWINGS.
  CONTRACTOR TO SUBMIT ALL SPRINKLER TYPES USED IN PROJECT.
- 6. AREAS ARE GENERAL IN NATURE. CONTRACTOR TO MATCH UNSCHEDULED AREAS TO SIMILAR SPACES.
- SPRINKLERS SHALL HAVE A 3MM QUICK RESPONSE BULB.
   SPRINKLERS SHALL BE RATED FOR A WORKING PRESSURE OF 250 PSI. SPRINKLERS SHALL BE UL LISTED.

|   | FIRE PROTECTION MATERIAL LIST  |
|---|--|
| SHALL VER   | OLS AND THE MATERIAL LIST ARE FOR THE CONVENIENCE OF THE CONTRACTOR. CONTRACTOR<br>HIFY QUANTITIES AND FURNISH ALL MATERIALS REQUIRED FOR FULLY OPERATIONAL SYSTEMS,<br>SPECIFIED OR NOT.  |
| CONTRACT<br>DESCRIPTI<br>DESCRIPTI  | NUMBERS SHALL NOT BE CONSIDERED COMPLETE, BUT ARE GIVEN AS AN AID TO THE TOR AND TO INDICATE THE QUALITY REQUIRED. CONTRACTOR IS RESPONSIBLE FOR COMPLETE ON OF MATERIAL ON THESE DRAWINGS AND IN THE SPECIFICATIONS BEFORE ORDERING. THE ON OF THE MATERIAL TAKES PRECEDENCE OVER THE CATALOG NUMBER. THE FIRST LISTED TURER IS THE BASIS OF DESIGN.  |
| ADV-1   |  |
| RING, CLO   | ON: AUTOMATIC DRIP VALVE, 250 PSI WP, BRASS BAR, STAINLESS STEEL SPRING AND RETAINING SING PRESSURE 13.5 PSI WITH INCREASING PRESSURE, OPENING PRESSURE 12.5 PSI WITH NG PRESSURE, 1/2" NPT INLET AND 1/4" NPT DRAIN OUTLET.   |
| MANUFACT  | TURER & CATALOG NO.: VIKING B-1, TYCO AD-1, RELIABLE C.  |
| <u>AV-1</u>   |  |
| DESCRIPTI<br>THREADED   | ON: ANGLE VALVE, 1/2" TO 2", 175 PSI, BRONZE BODY, INTEGRAL SEAT, SOFT DISC, HANDWHEEL, 0. UL.   |
| MANUFAC?  | URER & CATALOG NO.: UNITED 126S UL, NIBCO KT-67-UL / T-301-W, KENNEDY 98 SD, FPPI.   |
| <u>BF-1</u>   |  |
| <b>BRONZE O</b>   | <u>ON:</u> 2" TO 12" BUTTERFLY VALVE, 300 PSI WP, LUGGED OR GROOVED TYPE, IRON BODY, ALUMINUM<br>R EPDM COATED IRON DISC, STAINLESS STEEL STEM AND SCREWS, EPDM SEAT, INTEGRAL<br>SWITCH, RATED FOR DEAD END SERVICE, UL/FM.   |
| MANUFACT  | TURER & CATALOG NO.: NIBCO, GD-4765-8N, GEM, TYCO, KENNEDY, VICTAULIC 705-W, KENNEDY   |
| <u>CK-16</u>  |  |
|   | BRONZE SEAT RING AND RUBBER CLAPPER FACING, SWING TYPE, UL/FM.   |
| ANVIL/STAI<br>DESCRIPTI<br>AND RUBB   | ON: 1-1/2" TO 2" CHECK VALVE, 250 PSI WP, THREADED OR GROOVED, BRASS BODY, BRASS SEAT ER CLAPPER FACING, SPRING LOADED IN-LINE TYPE, UL/FM.  |
| ANVIL/STAI<br>DESCRIPTI<br>AND RUBB   | R 78FP ON: 1-1/2" TO 2" CHECK VALVE, 250 PSI WP, THREADED OR GROOVED, BRASS BODY, BRASS SEAT   |
| ANVIL/STAI<br>DESCRIPTI<br>AND RUBB   | R 78FP  ON: 1-1/2" TO 2" CHECK VALVE, 250 PSI WP, THREADED OR GROOVED, BRASS BODY, BRASS SEAT ER CLAPPER FACING, SPRING LOADED IN-LINE TYPE, UL/FM.  |
| ANVIL/STAI  DESCRIPTI AND RUBBI  MANUFACT  FDC-1  DESCRIPTI WITH DROI SWIVELS, I POLISHED   | R 78FP  ON: 1-1/2" TO 2" CHECK VALVE, 250 PSI WP, THREADED OR GROOVED, BRASS BODY, BRASS SEAT ER CLAPPER FACING, SPRING LOADED IN-LINE TYPE, UL/FM.  |
| ANVIL/STAI  DESCRIPTI AND RUBB  MANUFACT  FDC-1  DESCRIPTI WITH DROI SWIVELS, I POLISHED LOCAL FIR  | ON: 1-1/2" TO 2" CHECK VALVE, 250 PSI WP, THREADED OR GROOVED, BRASS BODY, BRASS SEAT ER CLAPPER FACING, SPRING LOADED IN-LINE TYPE, UL/FM.  "URER & CATALOG NO.: VIKING L-1/K-1.  ON: FLUSH FIRE DEPT. INLET CONNECTION, POLISHED CHROME PLATED TWO-WAY INLET BODY CLAPPERS, DOUBLE FEMALE CONNECTIONS WITH RIGID END N.P.T. X PIN LUG HOSE THREAD KNOX STAINLESS STEEL LOCKING FDC CAPS WITH MATCHING THREADS AND CHROME FINISH, CHROME PLATED WALL PLATE LABELED "AUTO. SPR." 4" X 2-1/2" X 2-1/2". UL. THREADS TO MATCH  |
| ANVIL/STAI  DESCRIPTI AND RUBB  MANUFACT  FDC-1  DESCRIPTI WITH DROIS SWIVELS, I POLISHED LOCAL FIR  CONTRACT   | ON: 1-1/2" TO 2" CHECK VALVE, 250 PSI WP, THREADED OR GROOVED, BRASS BODY, BRASS SEAT ER CLAPPER FACING, SPRING LOADED IN-LINE TYPE, UL/FM.  TURER & CATALOG NO.: VIKING L-1/K-1.  ON: FLUSH FIRE DEPT. INLET CONNECTION, POLISHED CHROME PLATED TWO-WAY INLET BODY POLISHED CHROME PLATED TWO-WAY INLET BODY ON STAINLESS STEEL LOCKING FDC CAPS WITH RIGID END N.P.T. X PIN LUG HOSE THREAD KNOX STAINLESS STEEL LOCKING FDC CAPS WITH MATCHING THREADS AND CHROME FINISH, CHROME PLATED WALL PLATE LABELED "AUTO. SPR." 4" X 2-1/2" X 2-1/2". UL. THREADS TO MATCH E DEPARTMENT.  FOR TO COORDINATE PURCHASE OF KNOX LOCKING CAP WITH LOCAL FIRE DEPARTMENT.  |
| ANVIL/STAI  DESCRIPTI AND RUBB  MANUFACT  PDC-1  DESCRIPTI WITH DROI SWIVELS, I POLISHED LOCAL FIRI CONTRACT  MANUFACT ELKHART 1  | ON: 1-1/2" TO 2" CHECK VALVE, 250 PSI WP, THREADED OR GROOVED, BRASS BODY, BRASS SEAT ER CLAPPER FACING, SPRING LOADED IN-LINE TYPE, UL/FM.  TURER & CATALOG NO.: VIKING L-1/K-1.  ON: FLUSH FIRE DEPT. INLET CONNECTION, POLISHED CHROME PLATED TWO-WAY INLET BODY POLISHED CHROME PLATED TWO-WAY INLET BODY ON STAINLESS STEEL LOCKING FDC CAPS WITH RIGID END N.P.T. X PIN LUG HOSE THREAD KNOX STAINLESS STEEL LOCKING FDC CAPS WITH MATCHING THREADS AND CHROME FINISH, CHROME PLATED WALL PLATE LABELED "AUTO. SPR." 4" X 2-1/2" X 2-1/2". UL. THREADS TO MATCH E DEPARTMENT.  FOR TO COORDINATE PURCHASE OF KNOX LOCKING CAP WITH LOCAL FIRE DEPARTMENT.  |
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| ANVIL/STAI  DESCRIPTI AND RUBB  MANUFACT  DESCRIPTI WITH DROI SWIVELS, I POLISHED LOCAL FIRI CONTRACT ELKHART 1  FS-1  DESCRIPTI FLOW OF 1 FROM 0-90  MANUFACT THE ASSEM  | ON: 1-1/2" TO 2" CHECK VALVE, 250 PSI WP, THREADED OR GROOVED, BRASS BODY, BRASS SEAT ER CLAPPER FACING, SPRING LOADED IN-LINE TYPE, UL/FM.  "URER & CATALOG NO.: VIKING L-1/K-1.  ON: FLUSH FIRE DEPT. INLET CONNECTION, POLISHED CHROME PLATED TWO-WAY INLET BODY POLISPERS, DOUBLE FEMALE CONNECTIONS WITH RIGID END N.P.T. X PIN LUG HOSE THREAD KNOX STAINLESS STEEL LOCKING FDC CAPS WITH MATCHING THREADS AND CHROME FINISH, CHROME PLATED WALL PLATE LABELED "AUTO. SPR." 4" X 2-1/2" X 2-1/2". UL. THREADS TO MATCH EDEPARTMENT.  OR TO COORDINATE PURCHASE OF KNOX LOCKING CAP WITH LOCAL FIRE DEPARTMENT.  TURER & CATALOG NO.: POTTER-ROEMER 5020 SERIES, CROKER 6010 SERIES, GUARDIAN 6024, 66.  ON: FLOW SWITCH - VANE TYPE FOR USE ON WET PIPE SPRINKLER SYSTEM TO DETECT A MINIMU OF GPM. TWO SINGLE POLE DOUBLE THROW SWITCHES WITH PNEUMATIC RETARD-ADJUSTABLE SECONDS WITH AUTOMATIC RESET, TAMPER RESISTANT METAL HOUSING. UL/FM.  |
| ANVIL/STAI  DESCRIPTI AND RUBB  MANUFACT  FDC-1  DESCRIPTI WITH DROI SWIVELS, I POLISHED LOCAL FIR  CONTRACT  MANUFACT  ELKHART 1  FS-1  DESCRIPTI FLOW OF 1 FROM 0-90  MANUFACT  FS-1 CAN E THE ASSEM A PRESSUI                                  | ON: 1-1/2" TO 2" CHECK VALVE, 250 PSI WP, THREADED OR GROOVED, BRASS BODY, BRASS SEAT ER CLAPPER FACING, SPRING LOADED IN-LINE TYPE, UL/FM.  "URER & CATALOG NO.: VIKING L-1/K-1.  ON: FLUSH FIRE DEPT. INLET CONNECTION, POLISHED CHROME PLATED TWO-WAY INLET BODY POLISPERS, DOUBLE FEMALE CONNECTIONS WITH RIGID END N.P.T. X PIN LUG HOSE THREAD KNOX STAINLESS STEEL LOCKING FDC CAPS WITH MATCHING THREADS AND CHROME FINISH, CHROME PLATED WALL PLATE LABELED "AUTO. SPR." 4" X 2-1/2". UL. THREADS TO MATCH EDEPARTMENT.  TOR TO COORDINATE PURCHASE OF KNOX LOCKING CAP WITH LOCAL FIRE DEPARTMENT.  "URER & CATALOG NO.: POTTER-ROEMER 5020 SERIES, CROKER 6010 SERIES, GUARDIAN 6024, 66.  ON: FLOW SWITCH - VANE TYPE FOR USE ON WET PIPE SPRINKLER SYSTEM TO DETECT A MINIMU 0 GPM. TWO SINGLE POLE DOUBLE THROW SWITCHES WITH PNEUMATIC RETARD-ADJUSTABLE SECONDS WITH AUTOMATIC RESET, TAMPER RESISTANT METAL HOUSING. UL/FM.  "URER & CATALOG NO.: SYSTEM SENSOR WFD SERIES, POTTER ELECTRIC VSR-F.  "SE PROVIDED AS A PART OF A MANIFOLD ASSEMBLY WITH BF-1 AND IT-1. EACH COMPONENT OF MBLY MUST MEET THE REQUIREMENTS OF ITS RESPECTIVE MATERIAL LIST DESCRIPTION. PROVID   |
| ANVIL/STAI  DESCRIPTI AND RUBB  MANUFACT  DESCRIPTI WITH DROI SWIVELS, I POLISHED LOCAL FIRI CONTRACT  MANUFACT ELKHART 1  FS-1  DESCRIPTI FLOW OF 1 FROM 0-90  MANUFACT THE ASSEMA PRESSUI  IT-1  DESCRIPTI INTEGRAL FLOW EQU                    | ON: 1-1/2" TO 2" CHECK VALVE, 250 PSI WP, THREADED OR GROOVED, BRASS BODY, BRASS SEAT ER CLAPPER FACING, SPRING LOADED IN-LINE TYPE, UL/FM.  "URER & CATALOG NO.: VIKING L-1/K-1.  ON: FLUSH FIRE DEPT. INLET CONNECTION, POLISHED CHROME PLATED TWO-WAY INLET BODY POLISPERS, DOUBLE FEMALE CONNECTIONS WITH RIGID END N.P.T. X PIN LUG HOSE THREAD KNOX STAINLESS STEEL LOCKING FDC CAPS WITH MATCHING THREADS AND CHROME FINISH, CHROME PLATED WALL PLATE LABELED "AUTO. SPR." 4" X 2-1/2". UL. THREADS TO MATCH EDEPARTMENT.  TOR TO COORDINATE PURCHASE OF KNOX LOCKING CAP WITH LOCAL FIRE DEPARTMENT.  "URER & CATALOG NO.: POTTER-ROEMER 5020 SERIES, CROKER 6010 SERIES, GUARDIAN 6024, 66.  ON: FLOW SWITCH - VANE TYPE FOR USE ON WET PIPE SPRINKLER SYSTEM TO DETECT A MINIMU 0 GPM. TWO SINGLE POLE DOUBLE THROW SWITCHES WITH PNEUMATIC RETARD-ADJUSTABLE SECONDS WITH AUTOMATIC RESET, TAMPER RESISTANT METAL HOUSING. UL/FM.  "URER & CATALOG NO.: SYSTEM SENSOR WFD SERIES, POTTER ELECTRIC VSR-F.  "SE PROVIDED AS A PART OF A MANIFOLD ASSEMBLY WITH BF-1 AND IT-1. EACH COMPONENT OF MBLY MUST MEET THE REQUIREMENTS OF ITS RESPECTIVE MATERIAL LIST DESCRIPTION. PROVID   |
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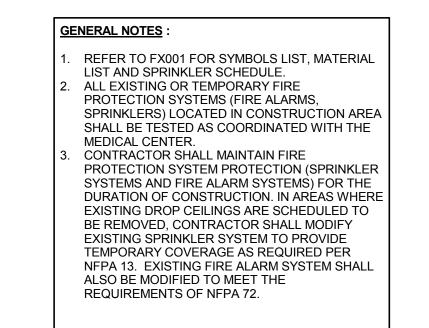
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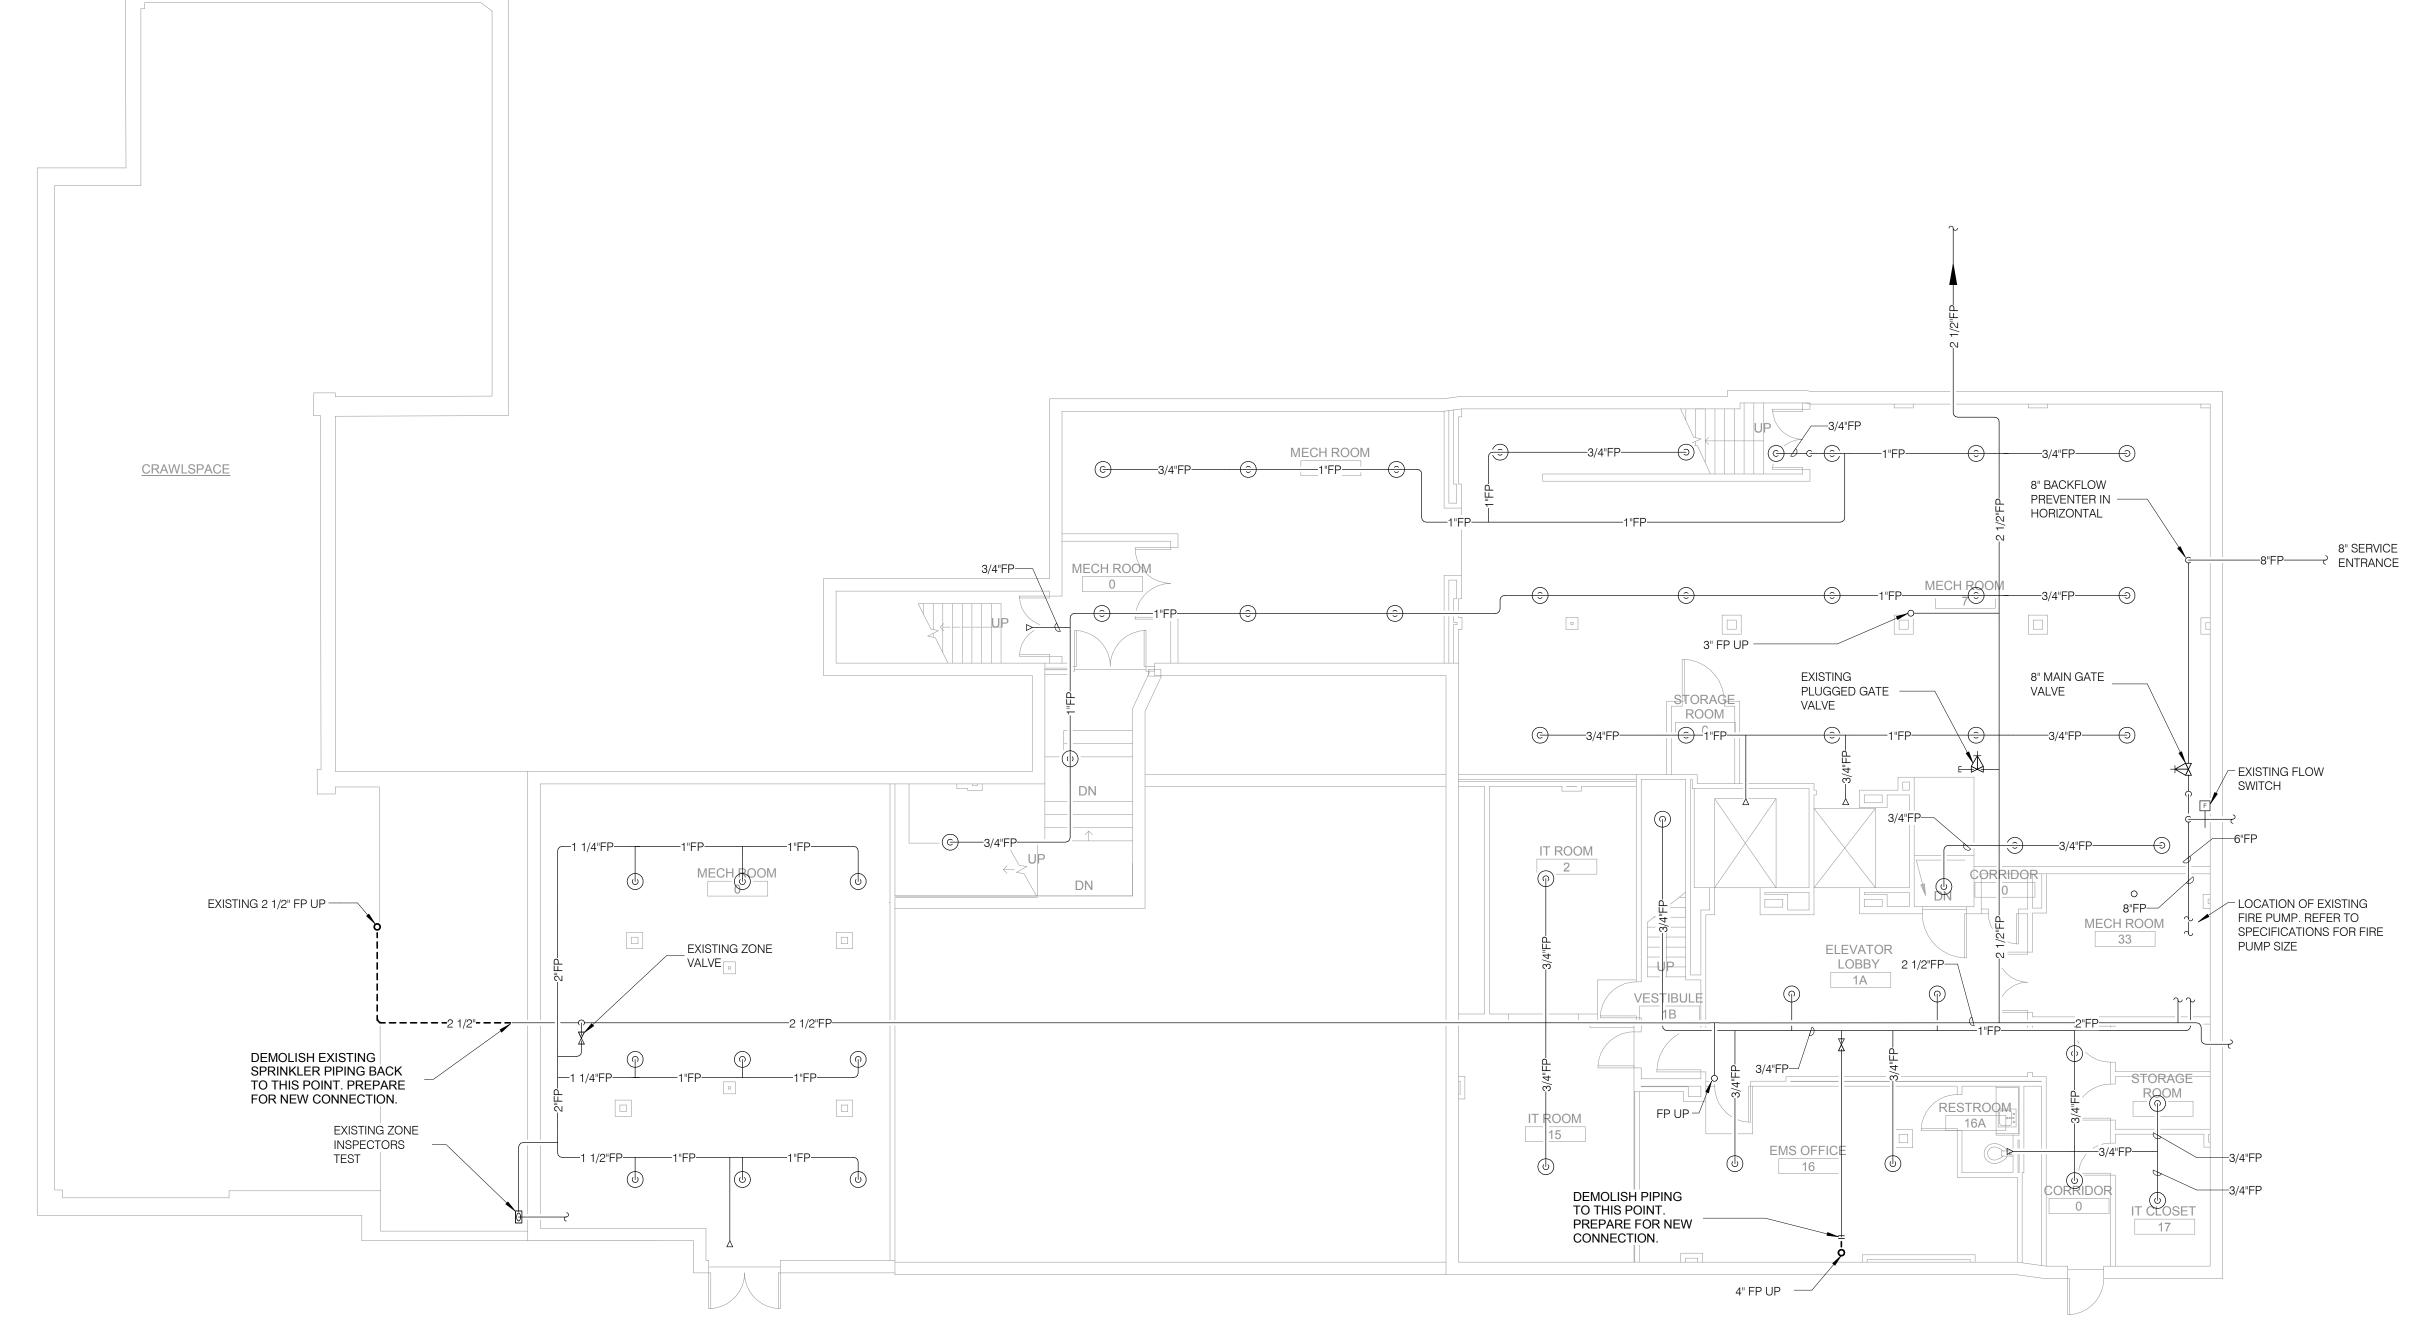
| RE PRO           | OTECTION SYMBOLS LIST DESCRIPTION:        |
|------------------|---|
|                  | EXISTING TO REMAIN                        |
|                  | EXISTING TO BE REMOVED                    |
|                  | NEW                                       |
| —FP——            | FIRE PROTECTION                           |
| FPD——            | FIRE PROTECTION DRAIN                     |
| <del></del> ə    | PIPE DOWN                                 |
| <u> </u>         | PIPE UP OR UP/DOWN                        |
| <del></del>      | NEW CONNECTION                            |
| ₹                | ANGLE VALVE                               |
| <b>☆</b>         | BUTTERFLY VALVE WITH MONITOR SWITCH       |
| _0_              | INSPECTOR TEST AND DRAIN VALVE            |
| <del>11</del>    | FIRE DEPARTMENT CONNECTION (WALL MOUNTED) |
| ⊏≍               | MONITOR SWITCH                            |
|                  | CHECK VALVE                               |
| _\$              | OS&Y GATE VALVE                           |
| F<br>—           | FLOW SWITCH                               |
| $\triangleright$ | SPRINKLER - WALL MOUNTED                  |
| 0                | SPRINKLER - CONCEALLED                    |
| •                | SPRINKLER                                 |
| IO HATCH         | LIGHT HAZARD                              |
|                  | ORDINARY GROUP 1                          |
|                  | ORDINARY GROUP 2                          |
| BFP              | BACKFLOW PREVENTER                        |
| C.C.             | CIVIL CONTRACTOR                          |
| C.O.R.           | CONTRACTING OFFICER REPRESENT             |
| F.P.C.           | FIRE PROTECTION CONTRACTOR                |
| G.C.             | GENERAL CONTRACTOR                        |
| M.C.             | MECHANICAL CONTRACTOR                     |
|                  | ELECTRICAL CONTRACTOR                     |
| P.C.             | PLUMBING CONTRACTOR                       |

| FIF | RE PROTECTION INSTALLATION NOTES:   |
|-----|---|
| 1.  | BUILDING IS CLASSIFIED AS LIGHT HAZARD. LABORATORIES, MECHANICAL EQUIPMENT ROOMS, ELECTRICAL CLOSETS AND SWITCHGEAR ROOMS ARE CLASSIFIED AS ORDINARY GROUP I. STORAGE ROOMS, CLEAN AND SOILED LINEN ROOMS ARE CLASSIFIED AS ORDINARY GROUP II. INSTALL SPRINKLERS IN ACCORDANCE WITH NFPA 13 REQUIREMENTS.  |
| 2.  | SEALED PER SPECIFICATIONS. VERIFY LOCATION OF ALL FIRE RATED WALLS / FLOORS, BARRIERS AND PARTITION WITH ARCHITECTURAL PLANS.   |
| 3.  | HYDRAULICALLY PER THE LATEST EDITION OF NFPA-13.  |
| 4.  | ALL SPRINKLERS TO BE CENTERED IN CEILING TILES WHERE APPLICABLE. REFER TO REFLECTED CEILING PLANS FOR CEILING TYPES AND VERIFY AT SITE.   |
| 5.  |   |
| 6.  | SPRINKLERS SHALL BE SPACED IN ACCORDANCE WITH THE LIGHTING AND MECHANICAL EQUIPMENT LAYOUT. THE FIRE PROTECTION CONTRACTOR SHALL LOCATE THE SPRINKLERS, REFERRING TO THE MECHANICAL DRAWINGS, TO PREVENT CONFLICTS WITH MECHANICAL EQUIPMENT. MECHANICAL EQUIPMENT LOCATION SHALL HAVE PRIORITY OVER SPRINKLER AND PIPING LOCATION. NO SPRINKLER PIPE SHALL PASS THROUGH AIR DUCTS OR STRUCTURAL MEMBERS. |
| 7.  | UNLESS NOTED OTHERWISE ON PLANS, PIPE SIZE SHALL BE HYDRAULICALLY CALCULATED BASED ON THE DESIGN APPROACH LISTED IN CHAPTER 11 OF NFPA 13. UTILIZE DENSITY AREA METHOD FOR HYDRAULIC CALCULATIONS. AREA REDUCTION FOR QUICK RESPONSE SPRINKLERS SHALL NOT BE USED.  |
| 8.  | VERIFY ALL PIPE ROUTING REVISIONS OR CHANGES OF SPRINKLER HEAD TYPE DUE TO EXISTING CONDITIONS WITH COR BEFORE PROCEEDING WITH CHANGE.  |

| 1.  | THE DRAWINGS ARE INTENDED TO INDICATE THE SCOPE OF DEMOLITION WORK REQUIRED AND DO NOT INDICATE EVERY PIPE, DUCT, OR PIECE OF |
|-----|---|
|     | EQUIPMENT THAT MUST BE REMOVED. THE CONTRACTOR SHALL VISIT THE  |
|     | SITE PRIOR TO SUBMITTING A BID AND VERIFY EXISTING CONDITIONS.  |
| 2.  | PROVIDE TEMPORARY CONNECTIONS TO MAINTAIN EXISTING SYSTEMS IN   |
|     | SERVICE DURING CONSTRUCTION. WHEN WORK MUST BE PERFORMED ON   |
|     | OPERATING EQUIPMENT, USE PERSONNEL EXPERIENCED IN SUCH OPERATIONS.  |
| 3.  | EXISTING FIRE SPRINKLER SYSTEM: MAINTAIN SERVICE TO FIRE SPRINKLER  |
| ٥.  | SYSTEM UNTIL NEW PIPING IS INSTALLED. OBTAIN PERMISSION FROM  |
|     | C.O.R. AT LEAST 24 HOURS BEFORE SHUTTING DOWN SYSTEM FOR ANY  |
|     | REASON. MAKE CHANGEOVER TO NEW PIPING WITH MINIMUM OUTAGE.  |
| 4.  | ALL SYSTEM CHANGEOVERS SHALL BE COMPLETED IN OVERTIME, NOT  |
| 5.  | DURING NORMAL WORKING HOURS. DEMOLISH AND EXTEND EXISTING FIRE SPRINKLER SYSTEM WORK UNDER                                    |
| J.  | PROVISIONS OF GENERAL CONDITIONS, SPECIFICATIONS AND THESE NOTES.   |
| 6.  | REMOVE, RELOCATE, AND EXTEND EXISTING INSTALLATIONS TO  |
|     | ACCOMMODATE NEW CONSTRUCTION.   |
| 7.  | REMOVE ABANDONED PIPING TO SOURCE OF SUPPLY AND/OR MAIN LINES.  |
| 8.  | REMOVE EXPOSED ABANDONED PIPING, INCLUDING ABANDONED PIPING   |
|     | ABOVE ACCESSIBLE CEILING FINISHES. CUT PIPING ABOVE CEILINGS, BELOW FLOORS AND BEHIND WALLS. CAP REMAINING LINES. REMOVE ALL  |
|     | ASSOCIATED CLAMPS, HANGERS, SUPPORTS, ETC., ASSOCIATED WITH   |
|     | PIPING REMOVAL.   |
| 9.  | DISCONNECT AND REMOVE MECHANICAL DEVICES AND EQUIPMENT SERVING  |
|     | EQUIPMENT THAT HAS BEEN REMOVED.  |
| 10. | REPAIR ADJACENT CONSTRUCTION AND FINISHES DAMAGED DURING  |
|     | DEMOLITION AND EXTENSION WORK. MATCH ORIGINAL CONSTRUCTION.   |
|     | VERIFY ALTERNATIVE OR SPECIAL REPAIR METHODS WITH COR BEFORE PROCEEDING WITH DEMOLITION.                                      |
| 11. | MAINTAIN ACCESS TO EXISTING MECHANICAL INSTALLATIONS WHICH REMAIN   |
|     | ACTIVE. MODIFY INSTALLATION OR PROVIDE ACCESS PANEL AS  |
|     | APPROPRIATE.  |
| 12. | EXTEND EXISTING INSTALLATIONS USING MATERIALS AND METHODS   |
|     | COMPATIBLE WITH EXISTING MECHANICAL INSTALLATIONS, OR AS  |
| 12  | SPECIFIED FOR INTENDED SERVICE. MECHANICAL ITEMS REMOVED AND NOT RELOCATED REMAIN THE   |
| 13. | PROPERTY OF THE C.O.R. THE CONTRACTOR SHALL BE RESPONSIBLE FOR  |
|     | THE DISPOSAL OF MATERIAL THE C.O.R. DOES NOT WANT TO REUSE OR   |
|     | RETAIN FOR MAINTENANCE PURPOSES.  |
|     |   |
|     |   |

|            | CONSULTANTS:  | ARCHITECT:  | Drawing Title               | Project Title RENOVATE AND EXPAND  AMBULATORY CARE AND LAB | Project Number 549-130 |                                |
|------------|---|---|-----------------------------|--|------------------------|--------------------------------|
|            | HEALTHCARE PLANNERS: VOA ARCHITECTS  MEPFP + TECH + STRUCT: KJWW CONSULTING ENGINEERS                     | MICHAEL ROTH & ASSOCIATES,  | FIRE PROTECTION COVER SHEET | SAM RAYBURN MEMORIAL  VETERANS CENTER                      |                        | Office of Facilities           |
|            | CIVIL ENGINEER: JD ENGINEERING  | ARCHITECTS & PLANNERS, INC.   | Approved: Project Director  | Location BONHAM, TEXAS                                     | Drawing Number         | Management                     |
| Revisions: | COST ESTIMATING: MOSS CONSTRUCTION COST MANAGEMENT INDUSTRIAL HYGIENE: JOHN A. JURGIEL & ASSOCIATES, INC. | 200 SOUTH HANLEY ROAD, STE. 1105, CLAYTON, MISSOURI 63105, 314-862-2112 |                             | Date Checked Drawn APRIL 13, 2015 LEWHAM BLAOBR            | FX001 Dwg. 101 of 14   | Department of Veterans Affairs |






UNEXCAVATED

VA FORM 08-6231, OCT 1978

BASEMENT FLOOR PLAN - FIRE PROTECTION - DEMO


|                 | CONSULTANTS:  | ARCHITECT:  | Drawing Title BASEMENT FLOOR PLAN - FIRE | Project Title RENOVATE AND EXPAND AMBULATORY CARE AND LAB. | Project Number 549-130 | Ott: t                         |
|-----------------|---|---|--|--|------------------------|--------------------------------|
|                 | HEALTHCARE PLANNERS: VOA ARCHITECTS  MEPFP + TECH + STRUCT: KJWW CONSULTING ENGINEERS | MICHAEL ROTH & ASSOCIATES,  | PROTECTION - DEMO                        |  | Building Number  1     | Office of Facilities           |
|                 | CIVIL ENGINEER: JD ENGINEERING  COST ESTIMATING: MOSS CONSTRUCTION COST MANAGEMENT    | ARCHITECTS & PLANNERS, INC.   | Approved: Project Director               | Location BONHAM, TEXAS                                     | Drawing Number FX101   | Management                     |
| Revisions: Date | INDUSTRIAL HYGIENE: JOHN A. JURGIEL & ASSOCIATES, INC.                                | 200 SOUTH HANLEY ROAD, STE. 1105, CLAYTON, MISSOURI 63105, 314-862-2112 |  | Date APRIL 13, 2015  Checked LEWHAM BLAOBR                 | Dwg. 102 of 142        | Department of Veterans Affairs |

1 2 5 5

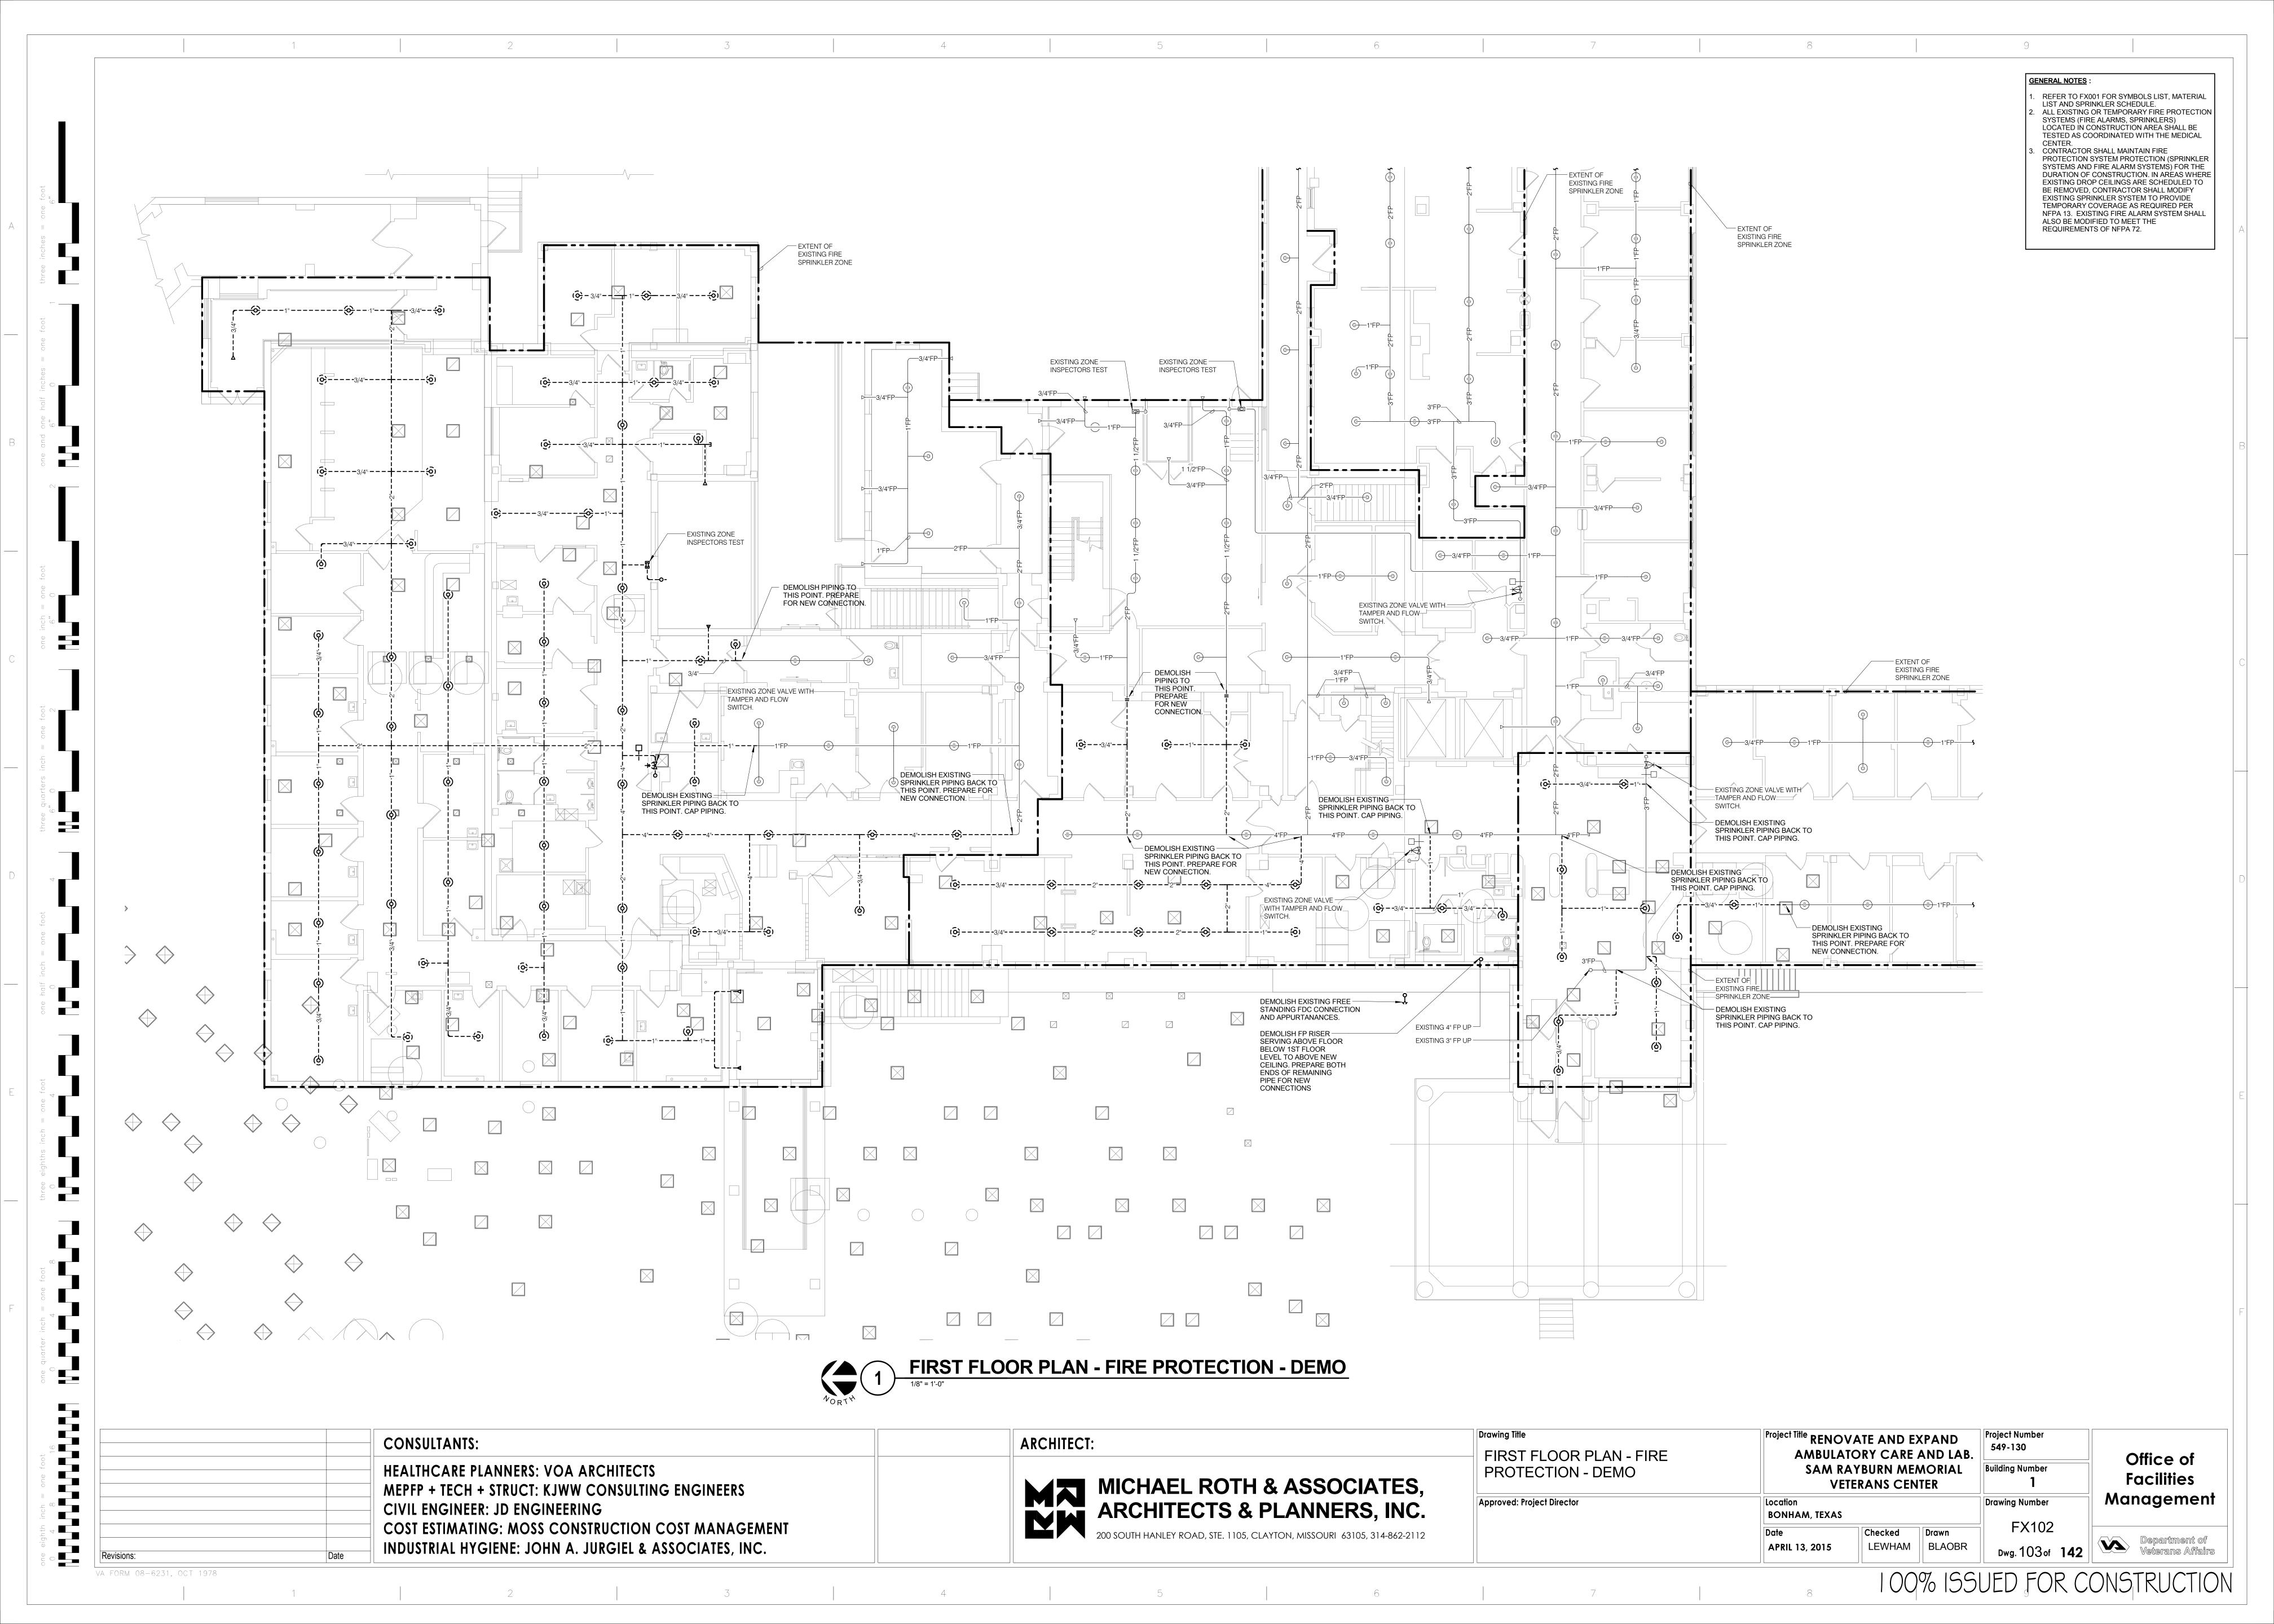

GENERAL NOTES:

1. REFER TO FX001 FOR SYMBOLS LIST, MATERIAL LIST AND SPRINKLER SCHEDULE.
2. CONTRACTOR SHALL MAINTAIN FIRE PROTECTION SYSTEM PROTECTION (SPRINKLER SYSTEMS AND FIRE ALARM SYSTEMS) FOR THE DURATION OF CONSTRUCTION. IN AREAS WHERE EXISTING DROP CEILINGS ARE SCHEDULED TO BE REMOVED, CONTRACTOR SHALL MODIFY EXISTING SPRINKLER SYSTEM TO PROVIDE TEMPORARY COVERAGE AS REQUIRED PER NFPA 13. EXISTING FIRE ALARM SYSTEM SHALL ALSO BE MODIFIED TO MEET THE REQUIREMENTS OF NFPA 72.

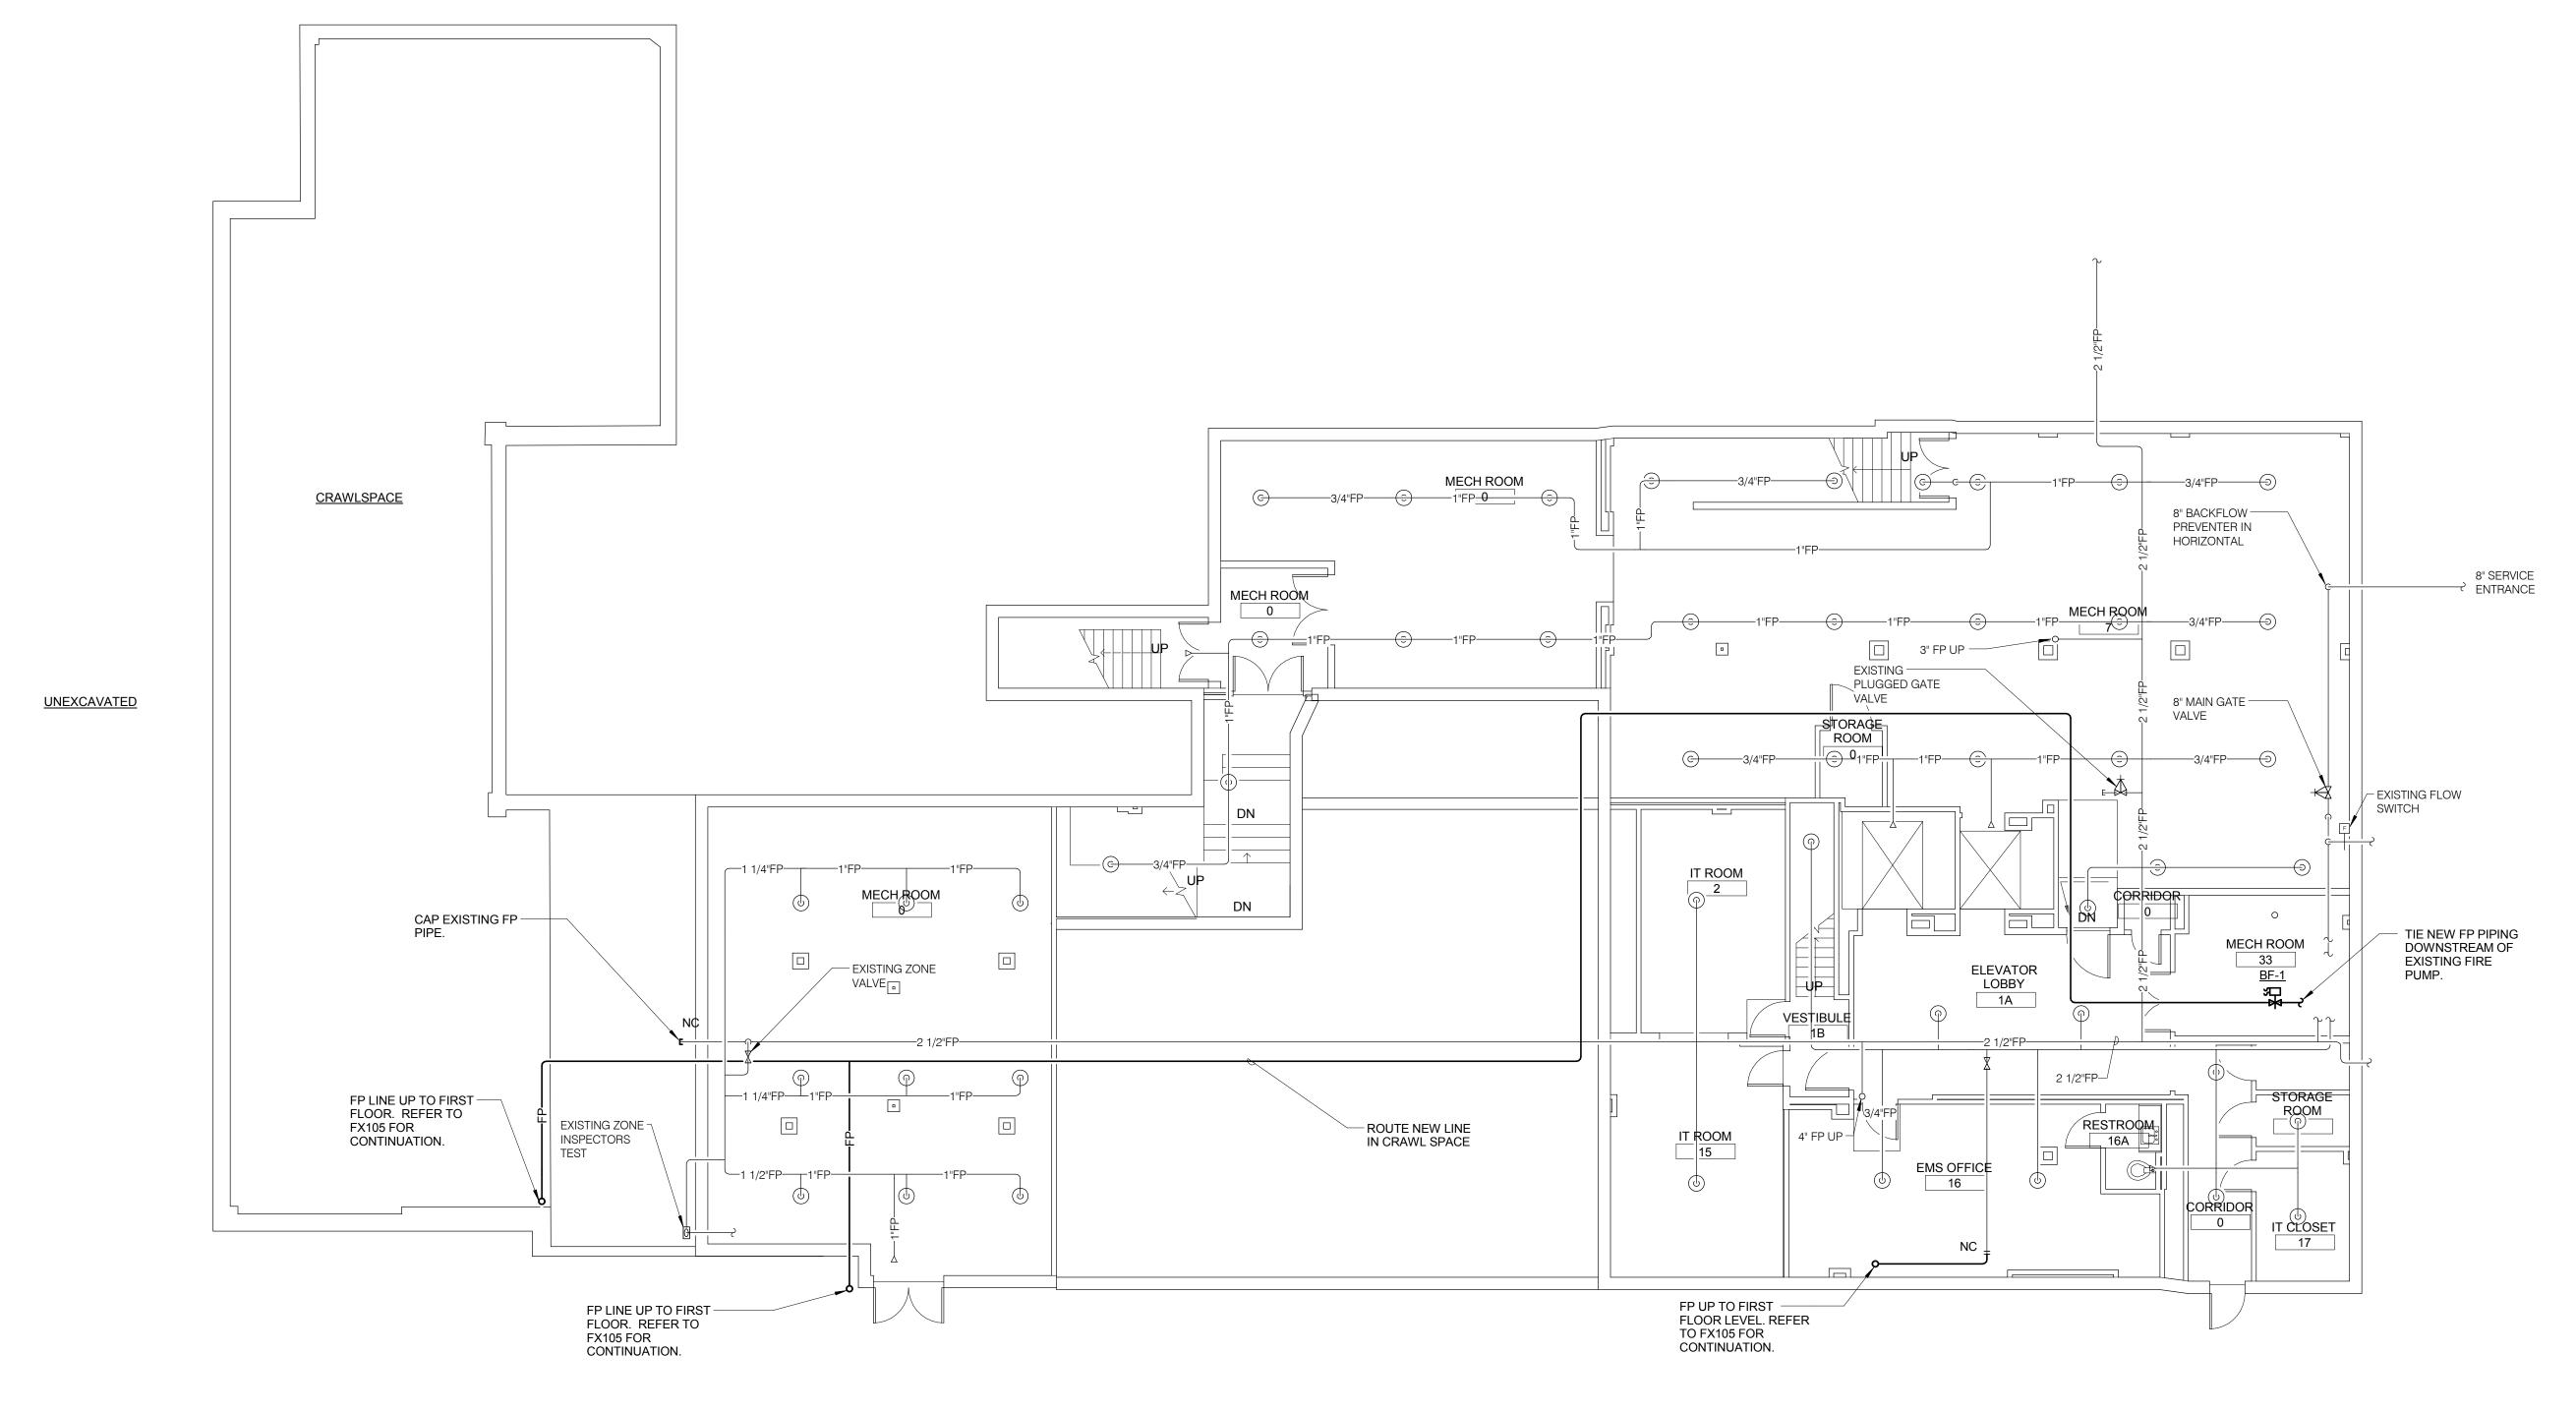





|                 | CONSULTANTS:   | ARCHITECT:  | Drawing Title  BASEMENT FLOOR PLAN - FIRE | Project Title RENOVATE AND EXPAND AMBULATORY CARE AND LAB. | Project Number 549-130 |                                |
|-----------------|--|---|---|--|------------------------|--------------------------------|
|                 | HEALTHCARE PLANNERS: VOA ARCHITECTS MEPFP + TECH + STRUCT: KJWW CONSULTING ENGINEERS | MICHAEL ROTH & ASSOCIATES.  | PROTECTION                                |  |                        | Office of Facilities           |
|                 | CIVIL ENGINEER: JD ENGINEERING COST ESTIMATING: MOSS CONSTRUCTION COST MANAGEMENT    | ARCHITECTS & PLANNERS, INC. 200 SOUTH HANLEY ROAD, STE. 1105, CLAYTON, MISSOURI 63105, 314-862-2112 | Approved: Project Director                | Location BONHAM, TEXAS  Date Checked Drawn                 | Drawing Number FX103   | Management                     |
| Revisions: Date | INDUSTRIAL HYGIENE: JOHN A. JURGIEL & ASSOCIATES, INC.                               | ■■■ F   |   | APRIL 13, 2015  LEWHAM BLAOBR                              | Dwg. 104 of 142        | Department of Veterans Affairs |

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VA FORM 08-6231, OCT 1978



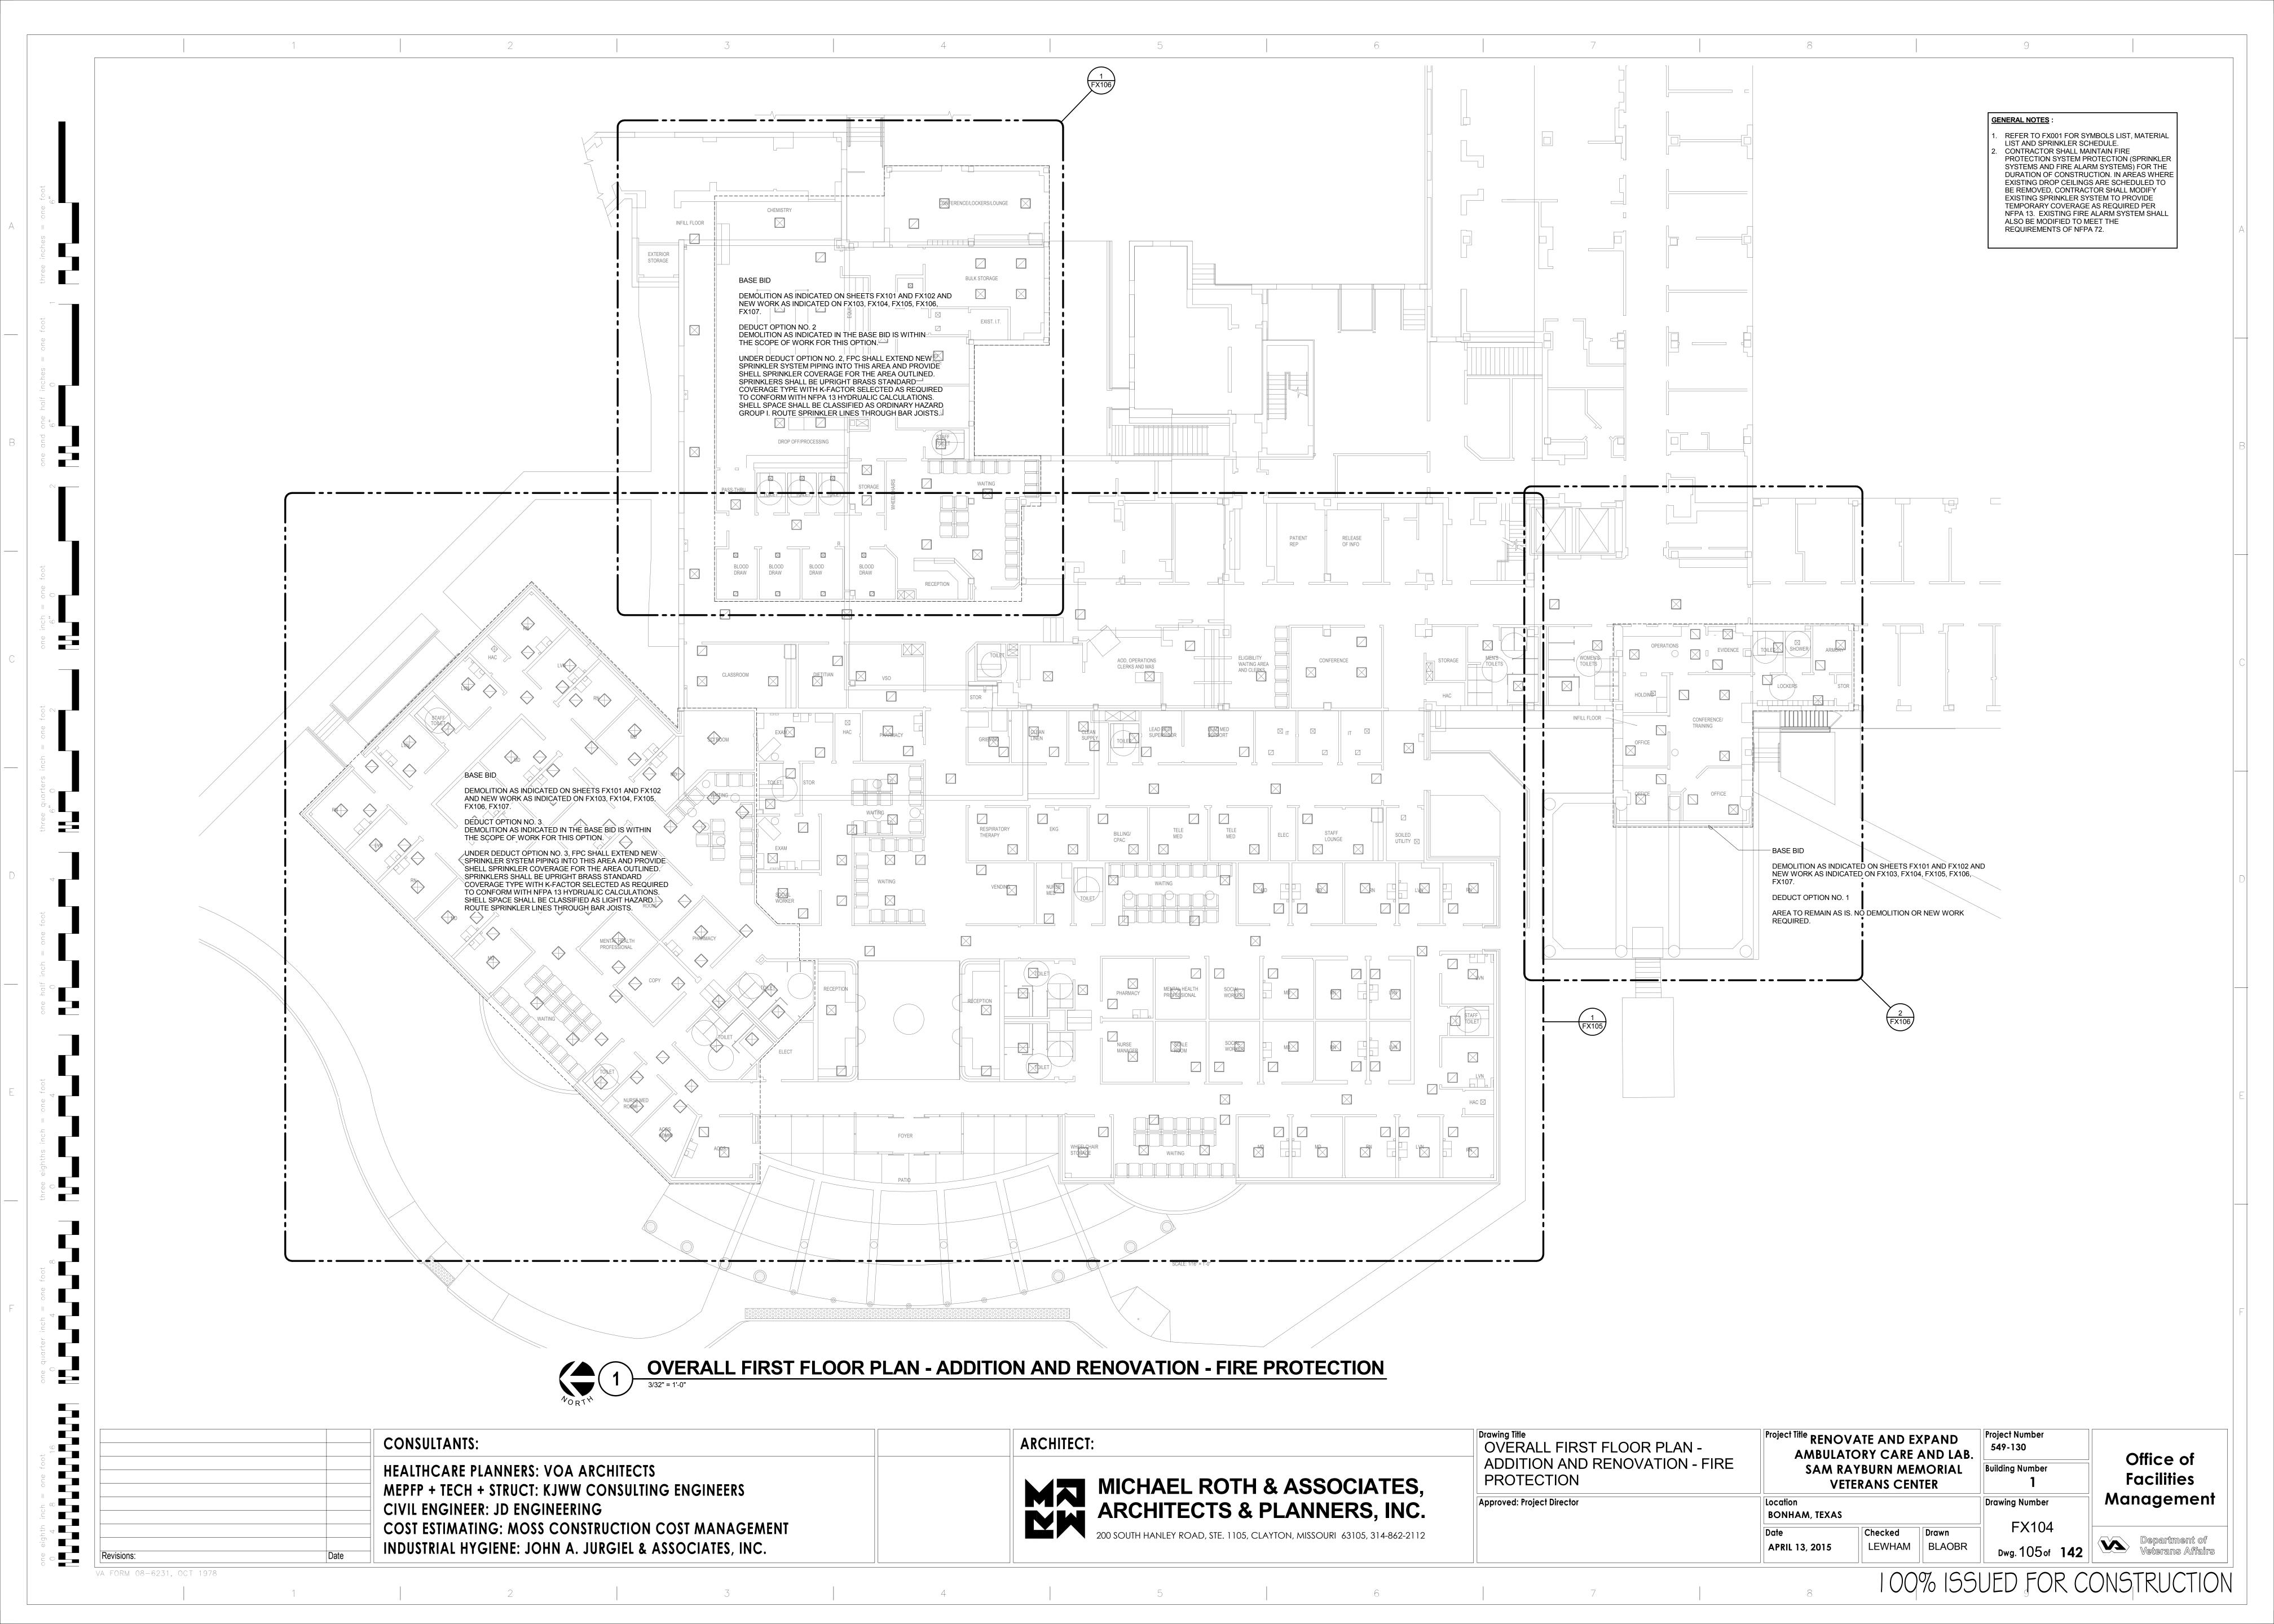


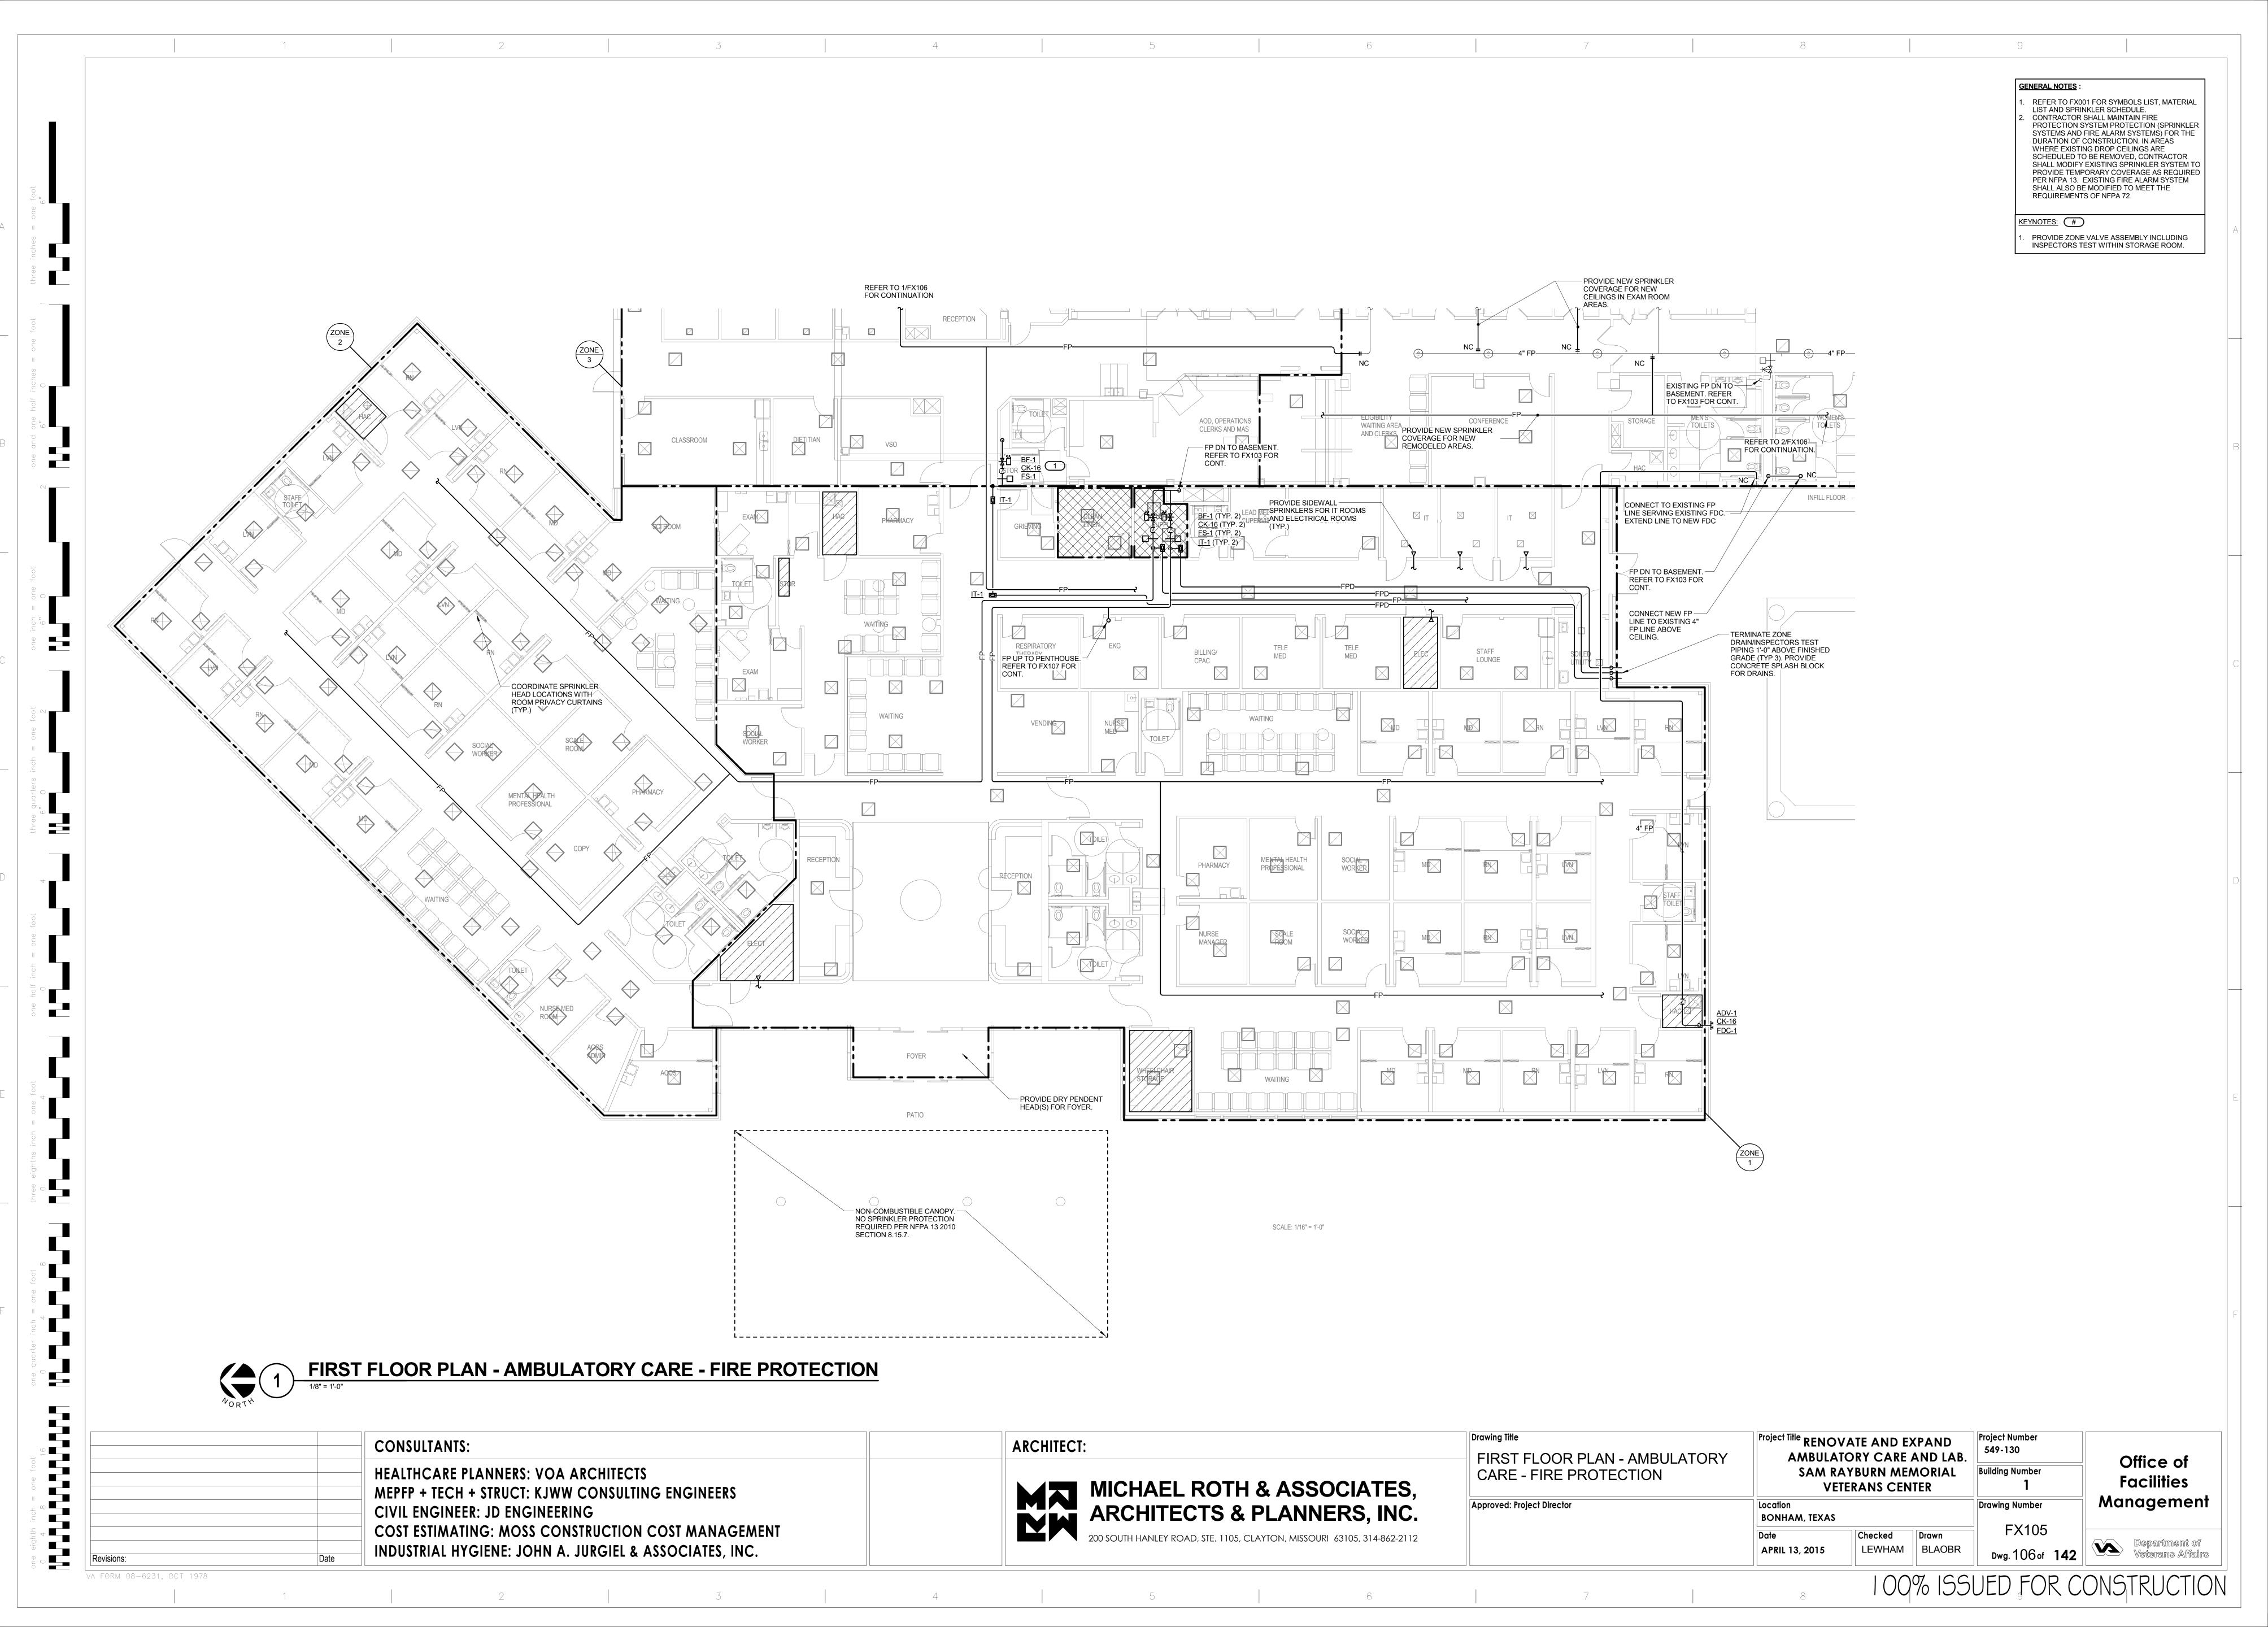GENERAL NOTES:


1. REFER TO FX001 FOR SYMBOLS LIST, MATERIAL LIST AND SPRINKLER SCHEDULE.
2. CONTRACTOR SHALL MAINTAIN FIRE PROTECTION SYSTEM PROTECTION (SPRINKLER SYSTEMS AND FIRE ALARM SYSTEMS) FOR THE DURATION OF CONSTRUCTION. IN AREAS WHERE EXISTING DROP CEILINGS ARE SCHEDULED TO BE REMOVED, CONTRACTOR SHALL MODIFY EXISTING SPRINKLER SYSTEM TO PROVIDE TEMPORARY COVERAGE AS REQUIRED PER NFPA 13. EXISTING FIRE ALARM SYSTEM SHALL ALSO BE MODIFIED TO MEET THE REQUIREMENTS OF NFPA 72.

KEYNOTES: #

1. PROVIDE SPR-5 FOR HOLDING ROOM. REFER TO FIRE SPRINKLER USAGE SCHEDULE FOR DETAILS.

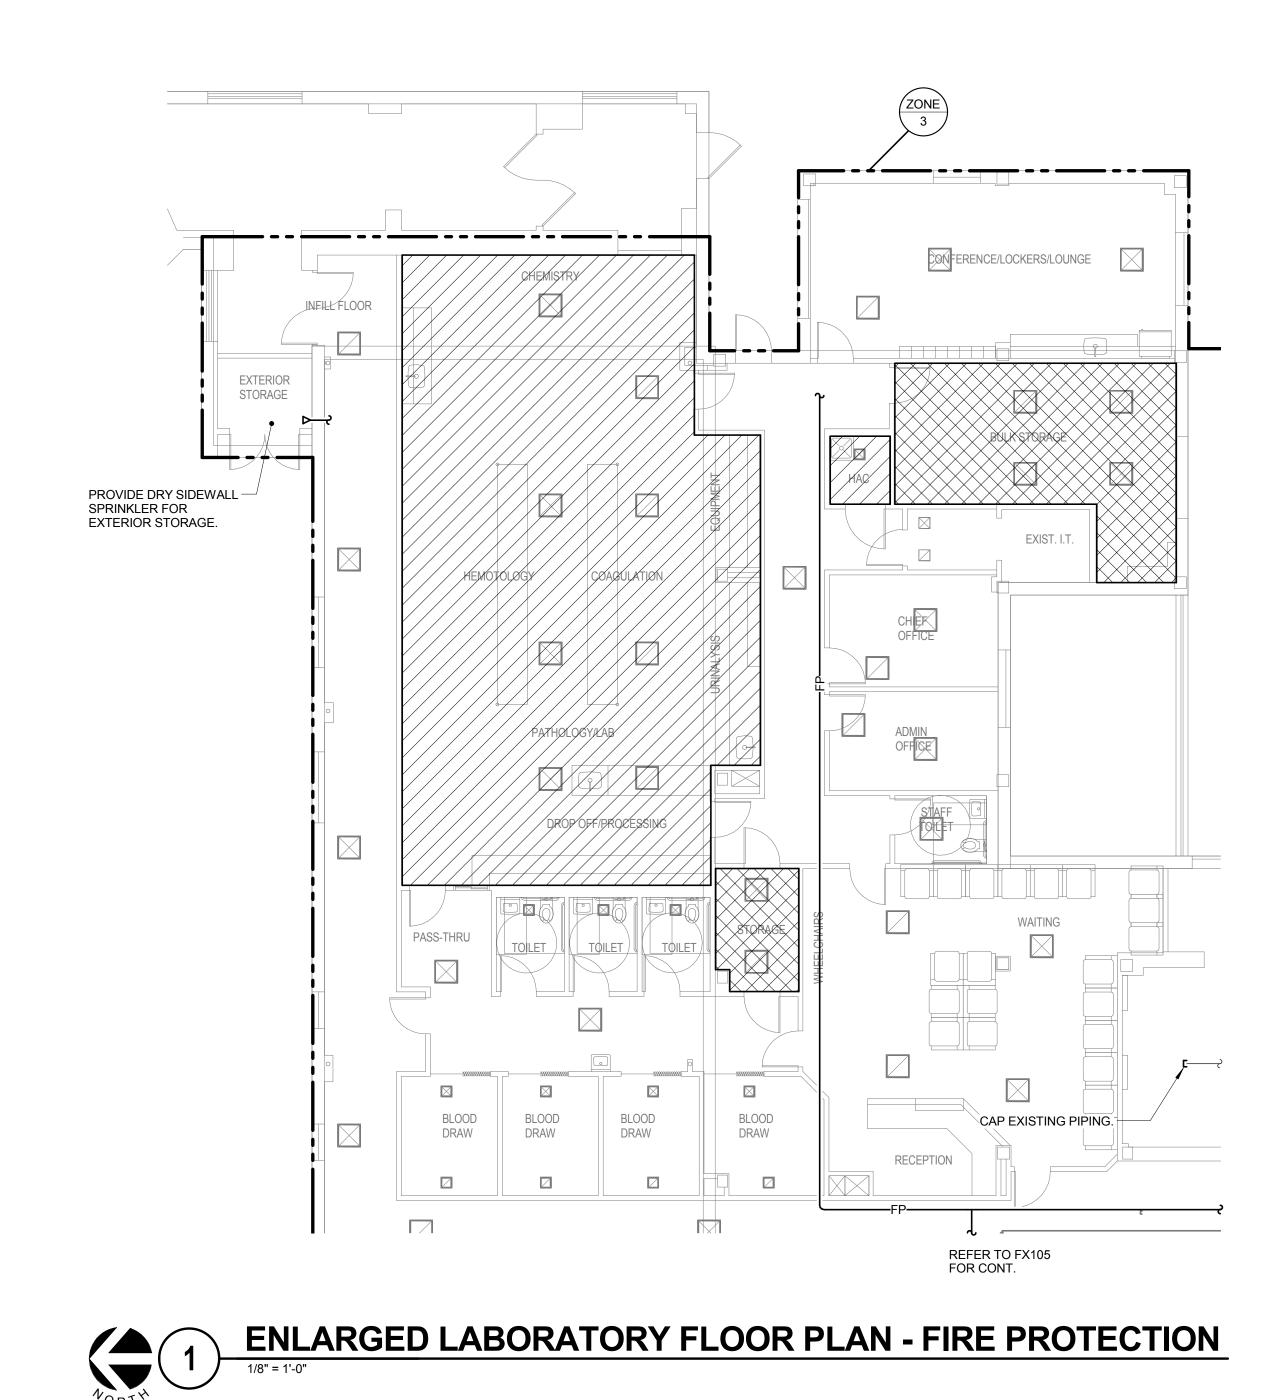

VA FORM 08-6231, OCT 1978

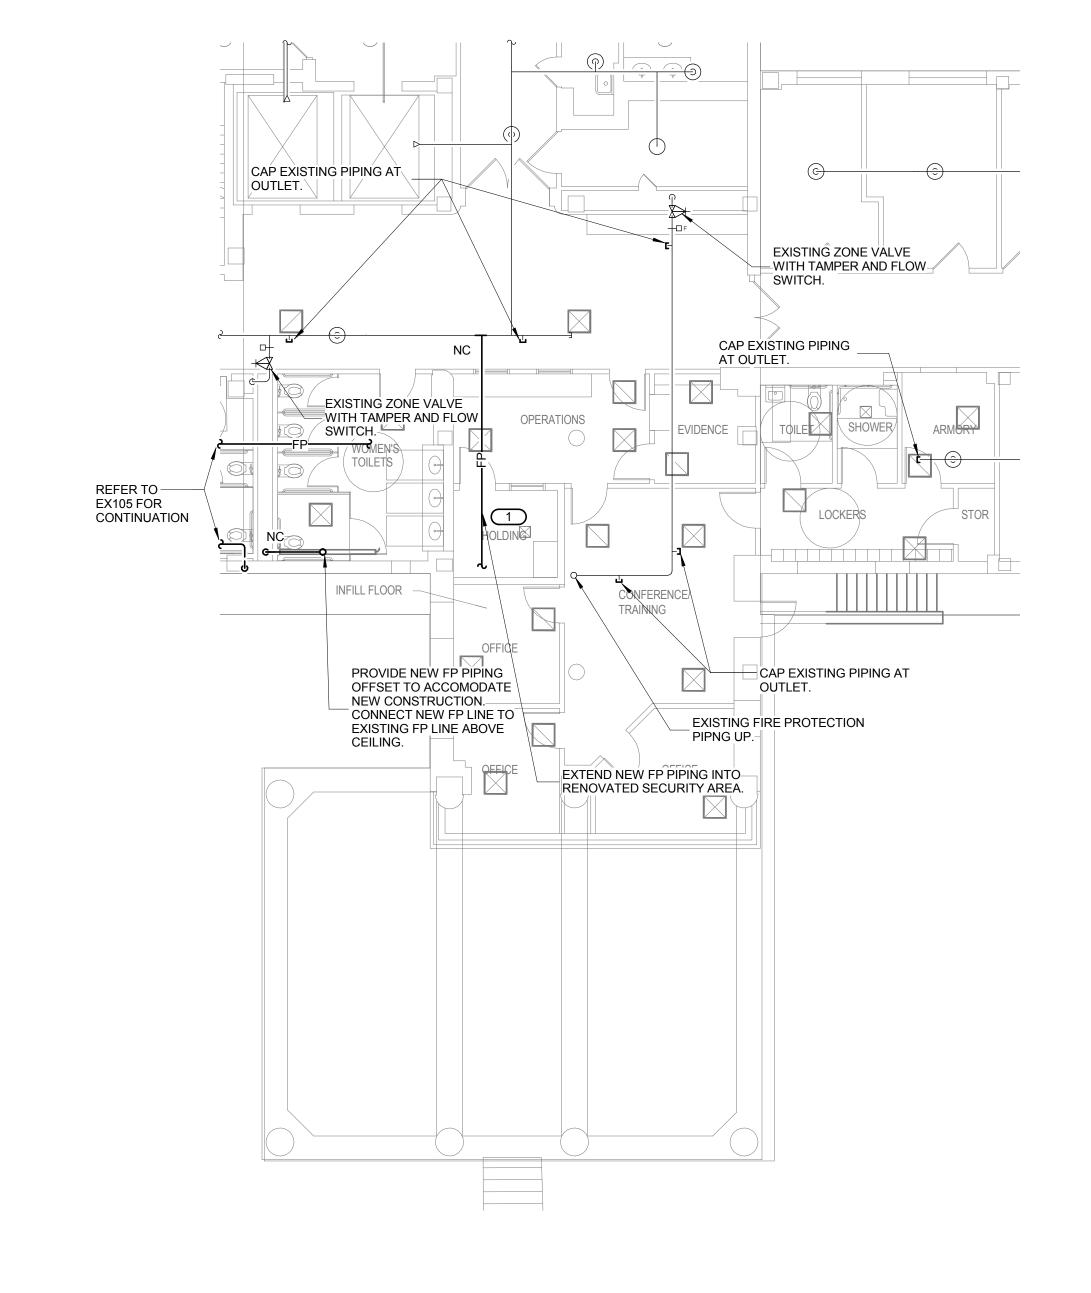


ENLARGED SECURITY FLOOR PLAN - FIRE PROTECTION

1/8" = 1'-0"

|            | CONSULTANTS:  | ARCHITECT:  | Drawing Title ENLARGED FLOOR PLAN -       | Project Title RENOVATE AND EXPAND  AMBULATORY CARE AND LAB. | Project Number 549-130 | Office of                      |
|------------|---|---|---|---|------------------------|--------------------------------|
|            | HEALTHCARE PLANNERS: VOA ARCHITECTS  MEPFP + TECH + STRUCT: KJWW CONSULTING ENGINEERS                     | MICHAEL ROTH & ASSOCIATES.  | LABORATORY AND SECURITY - FIRE PROTECTION |   | Building Number  1     | Office of Facilities           |
|            | CIVIL ENGINEER: JD ENGINEERING  | ARCHITECTS & PLANNERS, INC.   | Approved: Project Director                | Location<br>BONHAM, TEXAS                                   | Drawing Number         | Management                     |
| Revisions: | COST ESTIMATING: MOSS CONSTRUCTION COST MANAGEMENT INDUSTRIAL HYGIENE: JOHN A. JURGIEL & ASSOCIATES, INC. | 200 SOUTH HANLEY ROAD, STE. 1105, CLAYTON, MISSOURI 63105, 314-862-2112 |   | Date APRIL 13, 2015  Checked LEWHAM BLAOBR                  | FX106  Dwg. 107 of 142 | Department of Veterans Affairs |

1 2 5

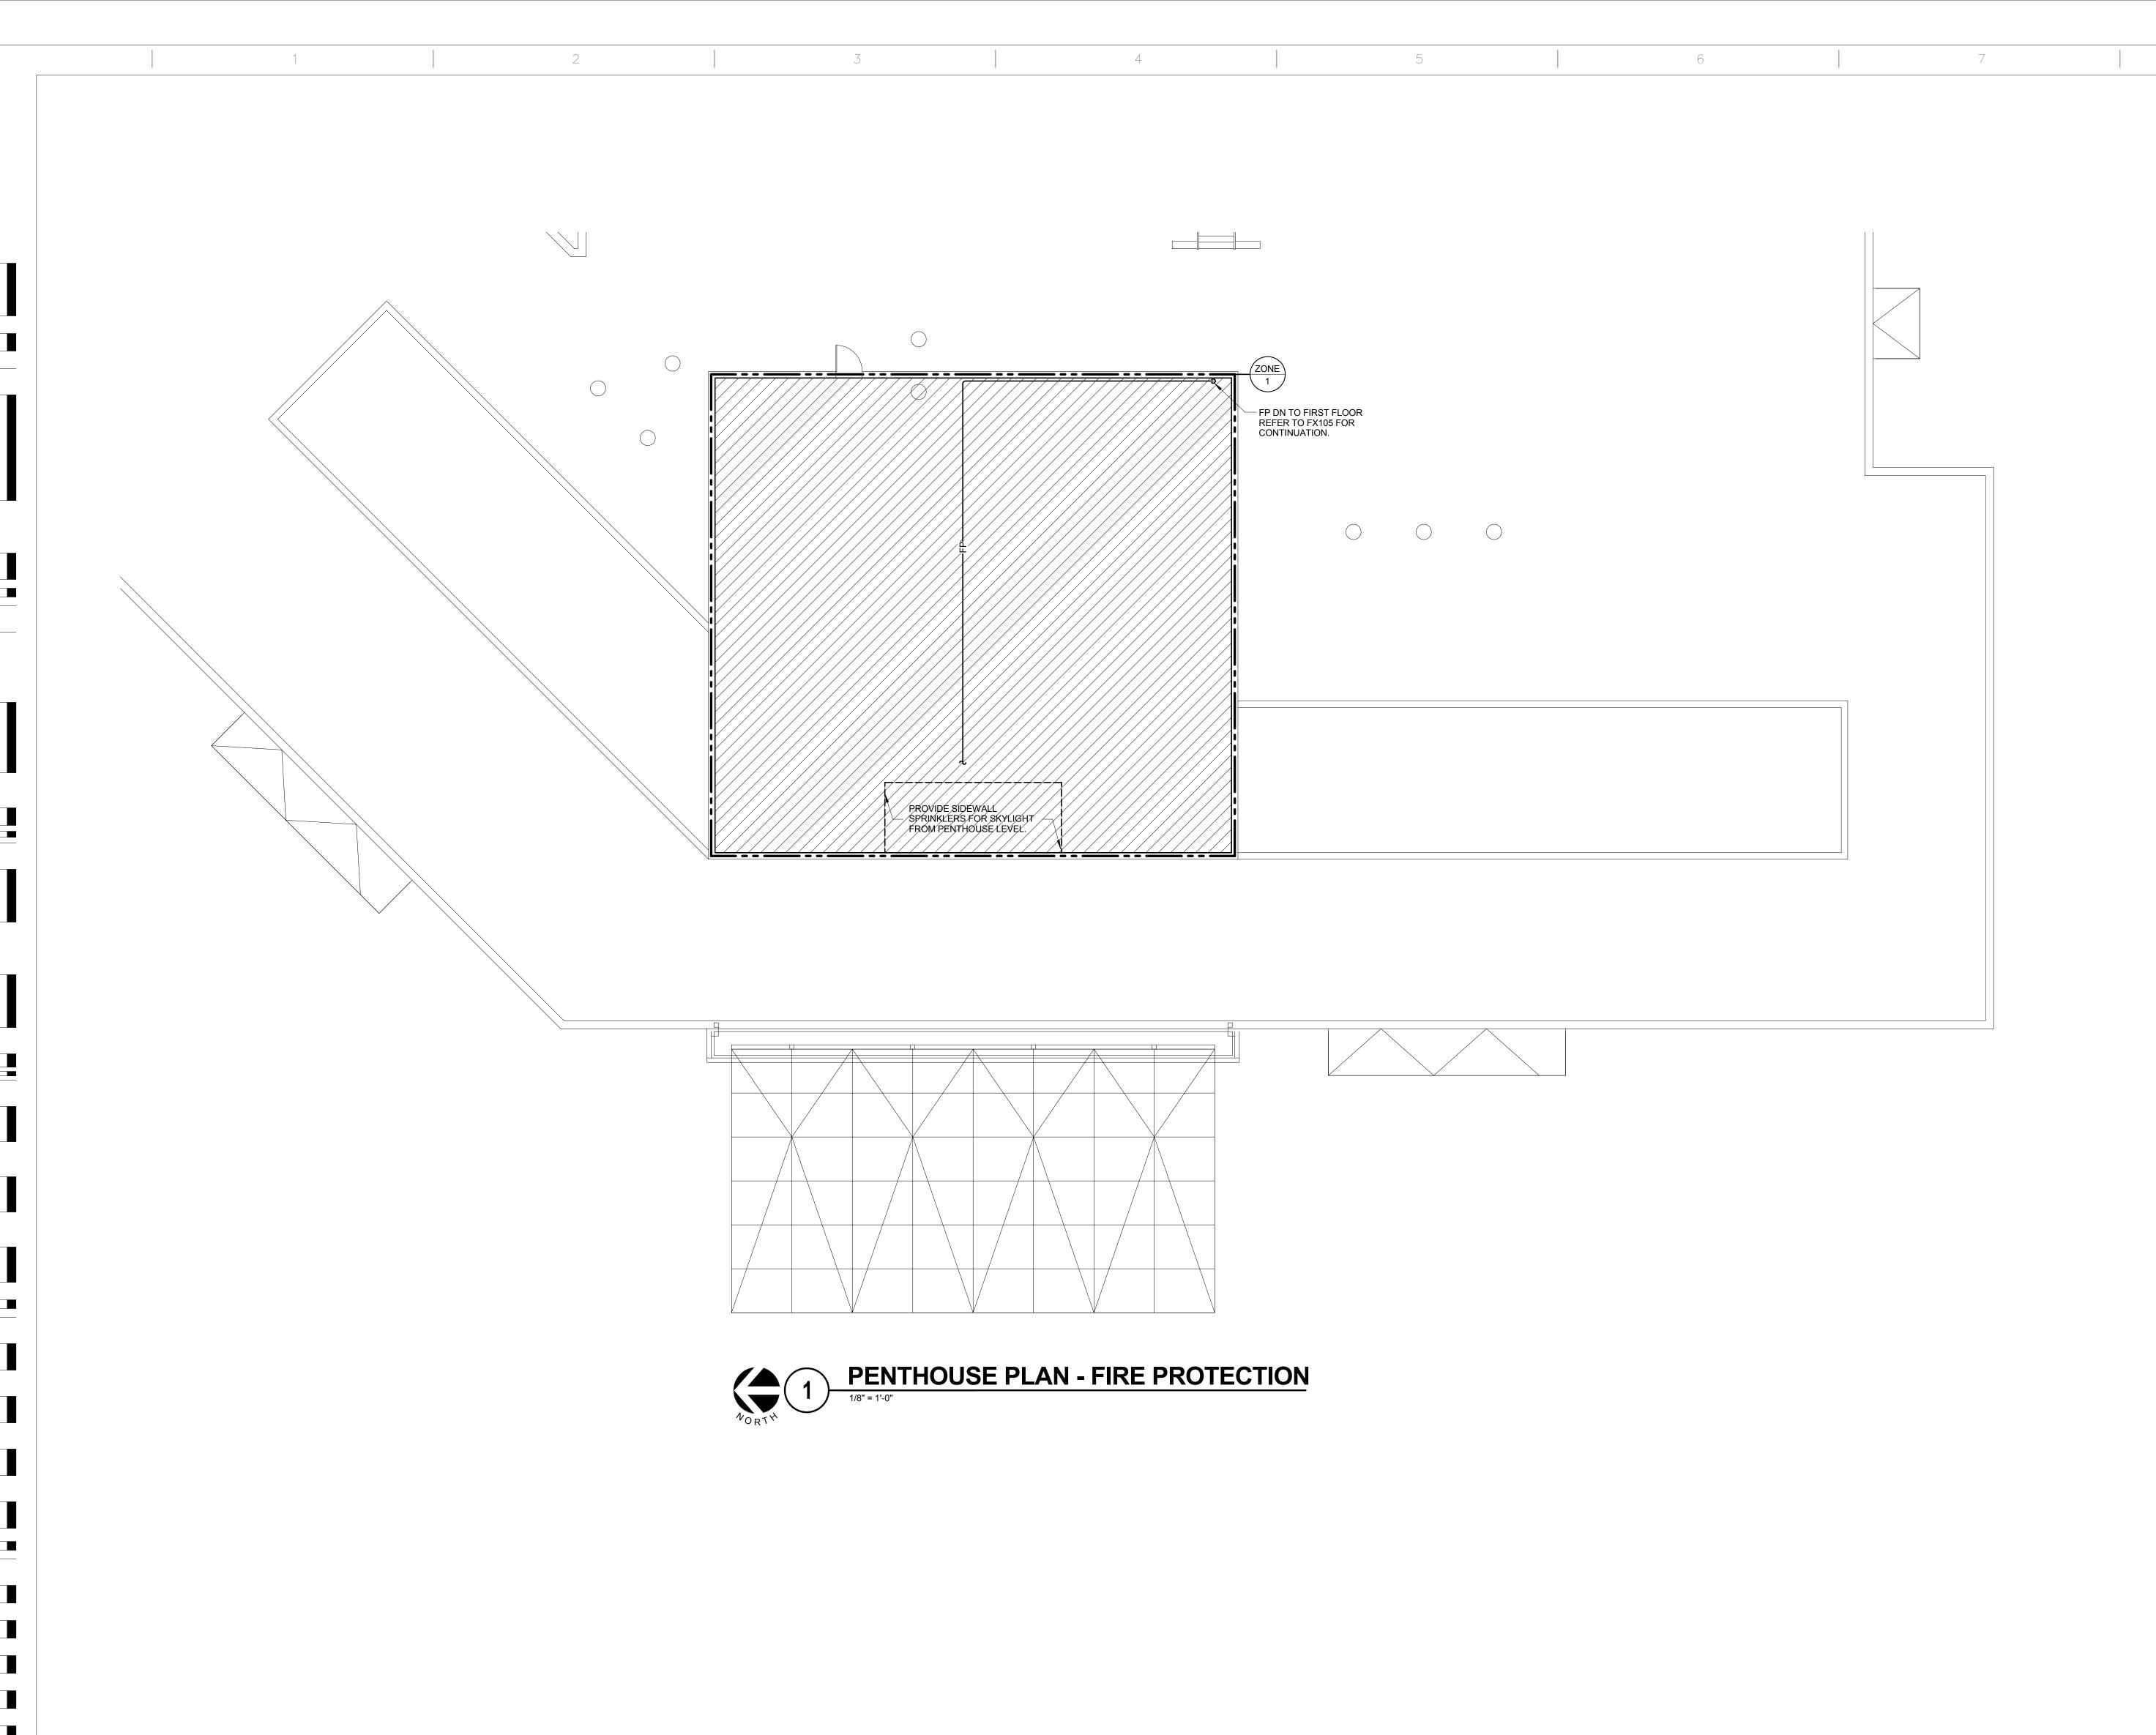

ARCHITECT:

MICHAEL ROTH & ASSOCIATES, ARCHITECTS & PLANNERS, INC. 200 SOUTH HANLEY ROAD, STE. 1105, CLAYTON, MISSOURI 63105, 314-862-2112

**CONSULTANTS:** 

VA FORM 08-6231, OCT 1978

HEALTHCARE PLANNERS: VOA ARCHITECTS

CIVIL ENGINEER: JD ENGINEERING

MEPFP + TECH + STRUCT: KJWW CONSULTING ENGINEERS

COST ESTIMATING: MOSS CONSTRUCTION COST MANAGEMENT

INDUSTRIAL HYGIENE: JOHN A. JURGIEL & ASSOCIATES, INC.

Drawing Title Project Title RENOVATE AND EXPAND 549-130 AMBULATORY CARE AND LAB. PENTHOUSE PLAN - FIRE Office of SAM RAYBURN MEMORIAL **Building Number** PROTECTION **Facilities VETERANS CENTER** Management Approved: Project Director Drawing Number BONHAM, TEXAS FX107 LEWHAM BLAOBR **APRIL 13, 2015** 

**GENERAL NOTES**:

REFER TO FX001 FOR SYMBOLS LIST, MATERIAL LIST AND SPRINKLER SCHEDULE.
 CONTRACTOR SHALL MAINTAIN FIRE PROTECTION SYSTEM PROTECTION (SPRINKLER SYSTEMS AND FIRE ALARM SYSTEMS) FOR THE

DURATION OF CONSTRUCTION. IN AREAS
WHERE EXISTING DROP CEILINGS ARE
SCHEDULED TO BE REMOVED, CONTRACTOR
SHALL MODIFY EXISTING SPRINKLER SYSTEM TO

PROVIDE TEMPORARY COVERAGE AS REQUIRED PER NFPA 13. EXISTING FIRE ALARM SYSTEM

SHALL ALSO BE MODIFIED TO MEET THE REQUIREMENTS OF NFPA 72.